
COMMUNITY COLLEGE OF PHILADELPHIA

17TH STREET AND SPRING GARDEN STREET PHILADELPHIA, PENNSYLVANIA

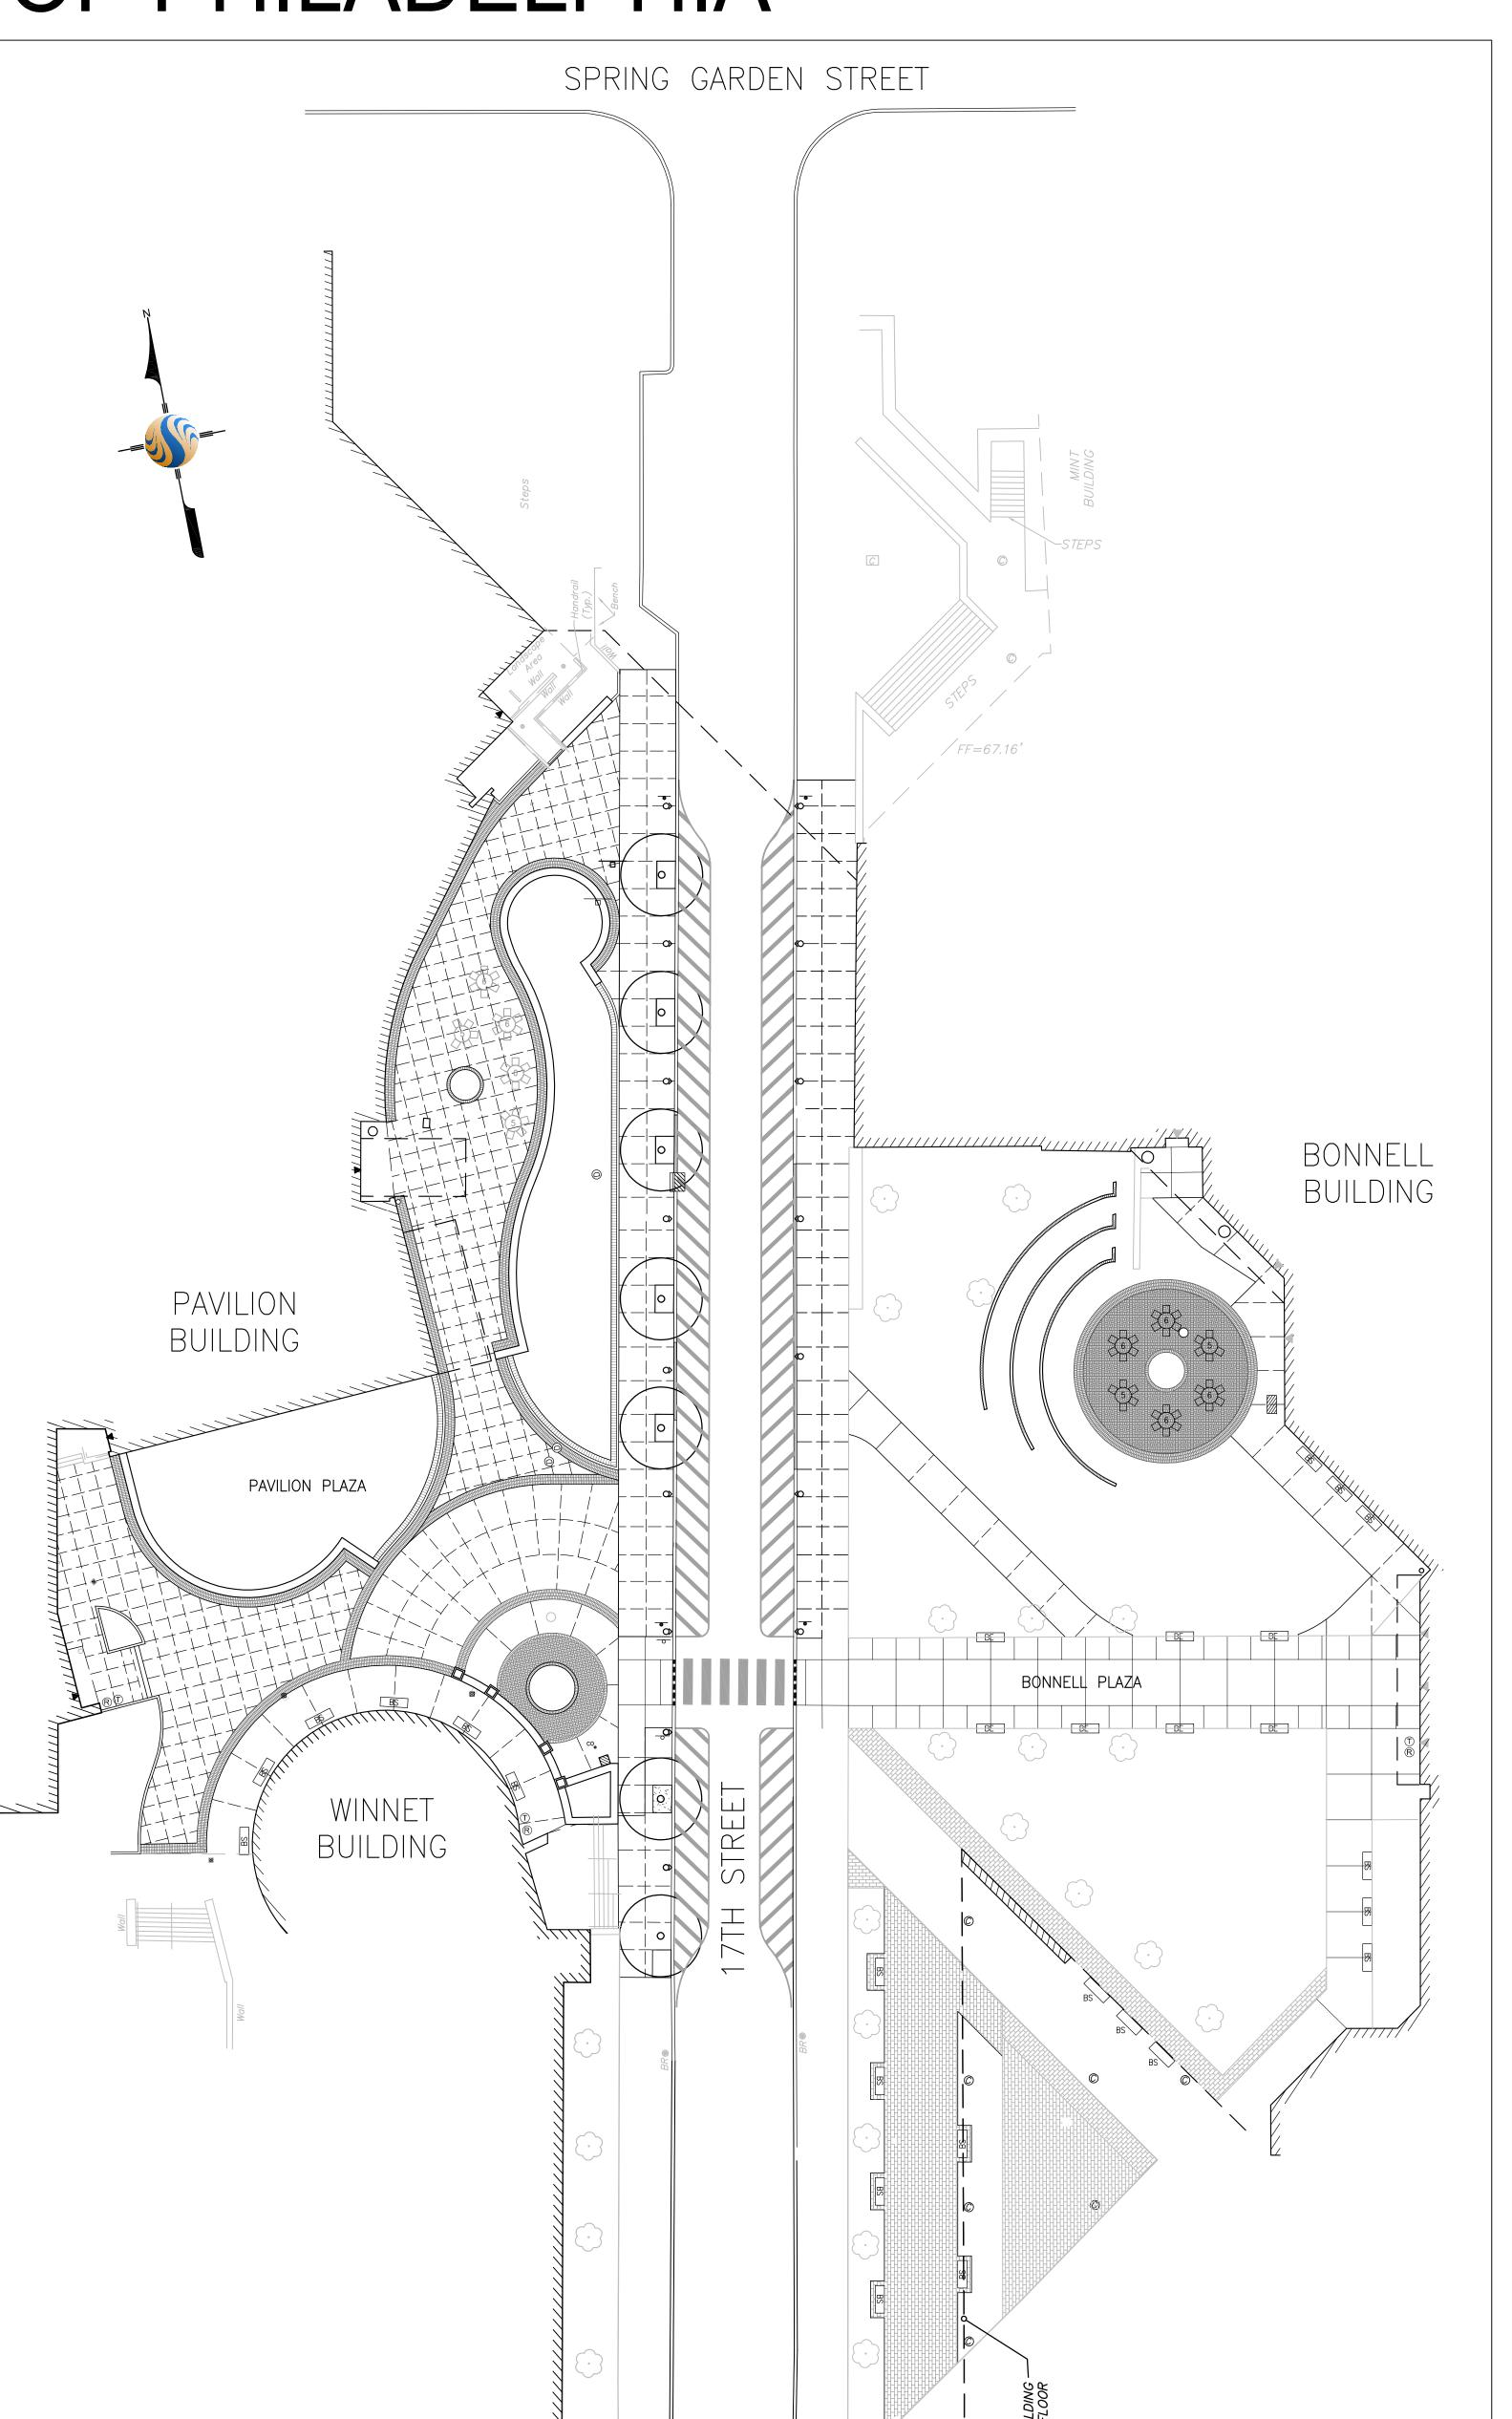

AREA OF WORK



Stantec Consulting Services I 1500 Spring Garden Suite 1100 Philadelphia PA 19130 Tel. 215.665.7000 Fax. 215.665.7001

Stante

Copyright F

The Contractor shall verify and be responsible for all dimensions. DO NOT scale the drawing — any errors or omissions shall be reported to Stantec without delay.

The Copyrights to all designs and drawings are the property of Stantec. Reproduction or use for any purpose other than that authorized by Stantec is forbidden.

Notes

DRAWING INDEX:

17TH STREET IMPROVEMENT PLAN

MODIFIED EXISTING CONDITIONS & DEMOLITION PLAN

EROSION & SEDIMENT CONTROL PLAN

CIVIL & LANDSCAPE CONSTRUCTION DETAILS

CIVIL & LANDSCAPE CONSTRUCTION DETAILS

17TH STREET LIGHTING & ELECTRICAL PLAN

ELECTRICAL & SITE LIGHTING PLAN

LIGHTING & ELECTRICAL DETAILS

ELECTRICAL & SITE LIGHTING PLAN PAVILION PLAZA

SITE LAYOUT & MATERIALS PLAN

NO. SHEET

G001 1 OF 14

C110 2 OF 14

C200 3 OF 14

C300 4 OF 14

C400 5 OF 14

C600 6 OF 14

C700 7 OF 14

C800 8 OF 14

C801 9 OF 14

L100 10 OF 14

E100 11 OF 14

E101 12 OF 14

E102 13 OF 14

E103 14 OF 14

CONTRACTOR SHALL NOTIFE UTILITE COMPANIES THREE (S) DATS PRIOR TO COMMENCING WORK TO COMPLY WITH PENNA. ACT

No.287. UTILITY COMPANIES HAVE ASSIGNED SERIAL #'S 2995492, 2995498, 2995507, TO THIS LOCATION BY HUNT ENGINEERING &

SERIAL #'S 20121790546, 20121790547 BY STANTEC CONSULTING SERVICES INC.

SHEET TITLE


COVER SHEET

GRADING PLAN

UTILITY PLAN

LANDSCAPE PLAN

BONNELL PLAZA

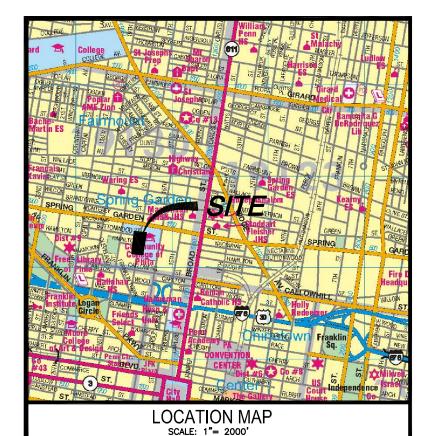

7 ISSUED FOR CONSTRUCTION	CPN	MJC	13.12.04
6 CHILLED WATER MAINS PER 6/2/1989 PLAN	CPN	MJC	13.10.25
5 CONSTRUCTION SET	CPN	MJC	13.10.18
4 ISSUED FOR OWNER REVIEW	WMC	MJC	13.08.30
3 SUBMISSION FOR STREETS DEPARTMENT REVIEW	CPN	MJC	13.08.30
2 SUBMISSION FOR OWNER'S APPROVAL	CPN	MJC	13.05.31
1 SUBMISSION TO CCP FOR BONNELL PLAZA CONSTRUCTION	CPN	MJC	13.05.10
Issued	Ву	Appd.	YY.MM.DD

File Name: 177901252-g001.dwg	LDL	MJC	LDL	13.0
	Dwn.	Chkd.	Dsgn.	YY.M
Permit-Seal				


Cliant/Project


COMMUNITY COLLEGE
OF PHILADELPHIA

PAVILION AND BONNELL PLAZAS & 17TH STREET IMPROVEMENTS Philadelphia, PA

itle COVER SHEET

Project No. 177901252	Scale 1"=20'	
Drawing No.	Sheet	Revision
G001	1 of 14	0

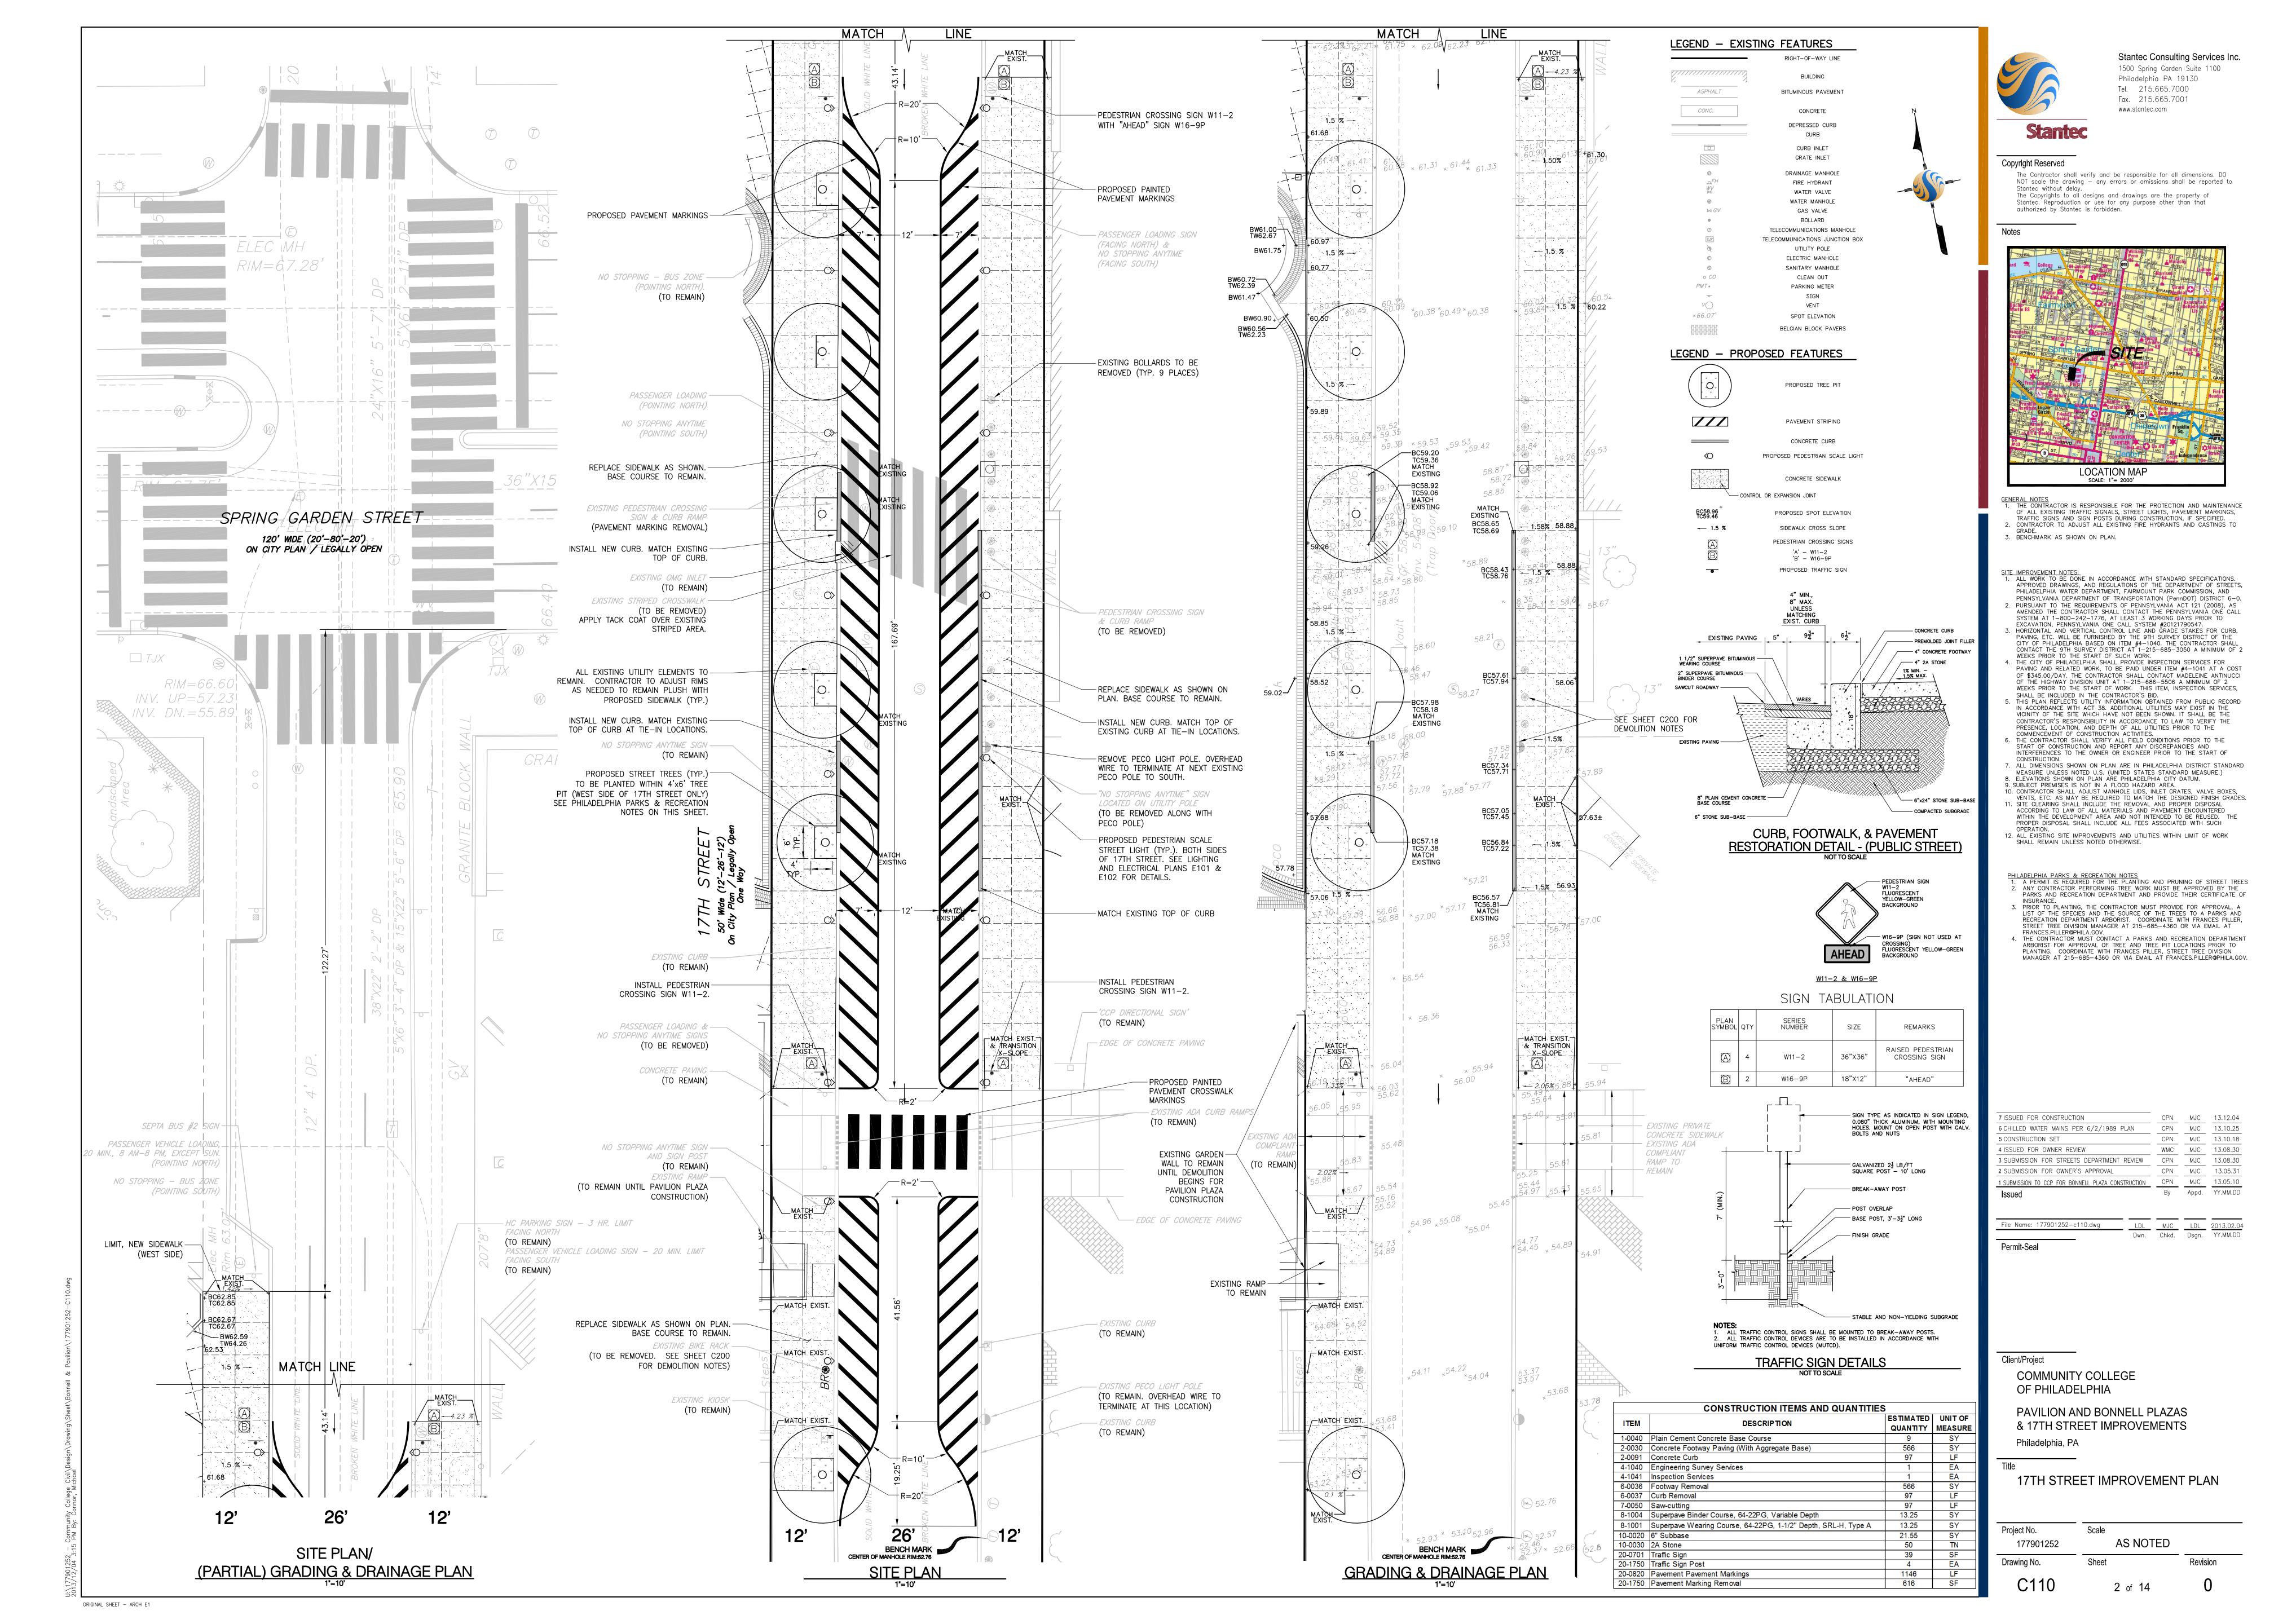

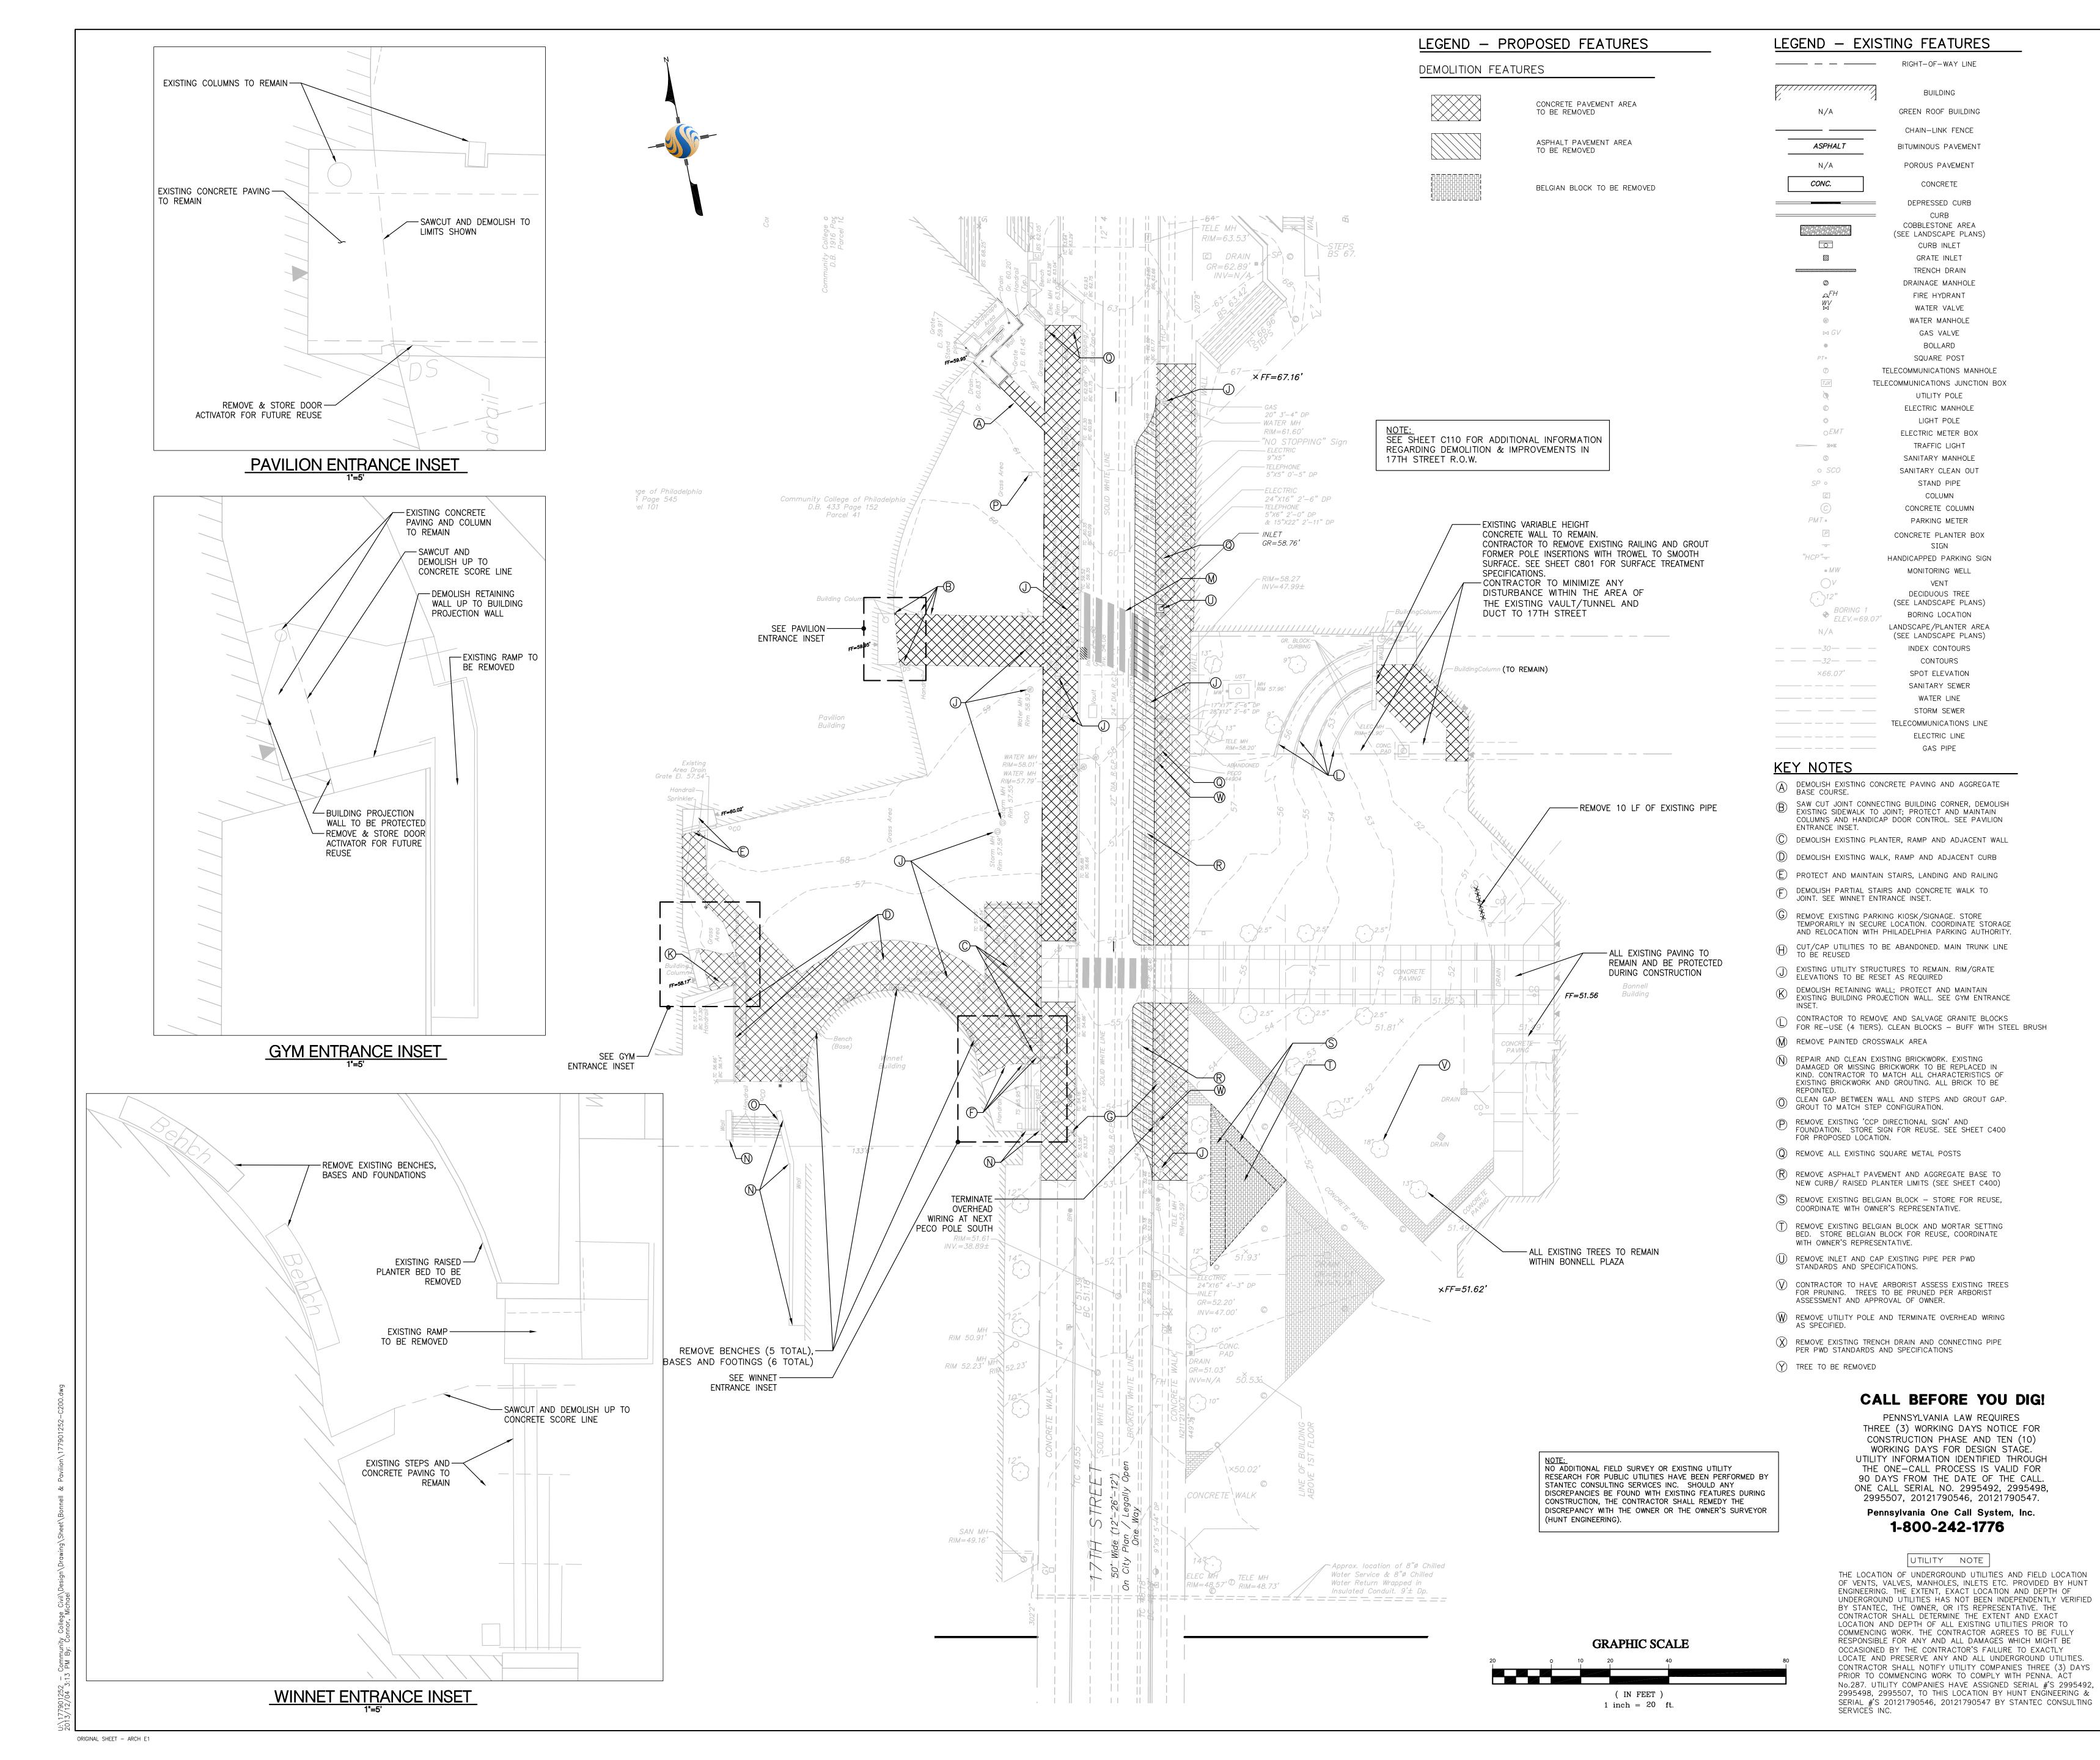




Stantec Consulting Services Inc. 1500 Spring Garden Suite 1100 Philadelphia PA 19130 Tel. 215.665.7000 Fax. 215.665.7001

Copyright Reserved

The Contractor shall verify and be responsible for all dimensions. DO NOT scale the drawing — any errors or omissions shall be reported to Stantec without delay The Copyrights to all designs and drawings are the property of Stantec. Reproduction or use for any purpose other than that authorized by Stantec is forbidden.

www.stantec.com

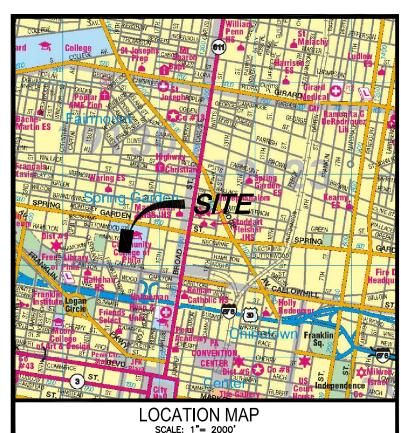

GENERAL NOTES:

1. ATTENTION IS CALLED TO THE PHILADELPHIA ZONING CODE AS AMENDED. PROPERTY IS ZONED IDD. SUBJECT PREMISES DOES NOT LIE WITHIN A FLOOD HAZARD AREA. SUBJECT PREMISES IS AN AREA "X" AS PER FEDERAL EMERGENCY MANAGEMENT AGENCY FLOOD INSURANCE MAP COMMUNITY PANEL 420757-0183G, LAST REVISED JANUARY

RIGHT OF WAY. PLAN MADE AS PER INSTRUCTIONS OF COMMUNITY COLLEGE OF PHILADELPHIA. ALL PROPOSED UTILITY SERVICES WILL BE UNDERGROUND OR WILL ENTER PROPOSED PROPERTY FROM THE PUBLIC RIGHT-OF-WAY.

UTILITIES ENTER THE PREMISES FROM PUBLIC STREETS OR

- THE CONTRACTOR SHALL CONFORM TO ALL THE REQUIREMENTS OF PA ACT 187 AS AMENDED. NO ADDITIONAL FIELD SURVEY OR EXISTING UTILITY RESEARCH FOR PUBLIC UTILITIES HAVE BEEN PERFORMED BY STANTEC CONSULTING SERVICES INC. SHOULD ANY DISCREPANCIES BE FOUND WITH EXISTING FEATURES DURING CONSTRUCTION, THE
- CONTRACTOR SHALL REMEDY THE DISCREPANCY WITH THE OWNER OR THE OWNER'S SURVEYOR (HUNT ENGINEERING). CHILLED WATER MAINS LOCATED SOUTH OF BONNELL AND WINNET BUILDINGS (CROSSING 17TH STREET) ARE APPROXIMATELY LOCATED PER PLAN TITLED "PARTIAL SITE PLAN. DETAILS & DIAGRAMS. MECHANICAL" FOR PROJECT TITLED COMMUNITY COLLEGE OF PHILADELPHIA STUDENT LIFE AND INSTRUCTION BUILDING AND GYMNASIUM BUILDING DATED

DEMOLITION NOTES:

1. CONTRACTOR TO COORDINATE ALL DEMOLITION WORK WITH THE ARCHITECTURAL PLANS. ALL WORK SHOWN ON THE ARCHITECTURAL PLANS SUPERCEDES THIS SHEET. CONTRACTOR SHALL CARRY OUT DEMOLITION IN SUCH WAY AS TO PROTECT SITE ELEMENTS TO REMAIN. SITE ELEMENTS DAMAGED BY THE CONTRACTOR'S ACTIVITIES SHALL BE REPAIRED OR REPLACED AT NO ADDITIONAL COST TO THE

- SITE CLEARING SHALL INCLUDE THE REMOVAL AND PROPER DISPOSAL, ACCORDING TO LAW OF, ALL MATERIALS, PAVEMENT ENCOUNTERED WITHIN THE DEVELOPMENT AREA. WHETHER SHOWN OR NOT. ALL DEMOLITION DEBRIS SHALL BE DISPOSED OF AT AN APPROVED LANDFILL IN ACCORDANCE WITH ALL APPLICABLE GOVERNMENTAL LAWS AND REGULATIONS. PROPER DISPOSAL SHALL INCLUDE ALL FEES ASSOCIATED WITH SUCH DISPOSAL. BURNING OF DEMOLITION DEBRIS IS NOT
- DEMOLITION AND REMOVAL OF DEMOLITION DEBRIS SHALL BE CONDUCTED IN SUCH A MANNER AS TO PREVENT THE SEDIMENTATION OF THE EXISTING DRAINAGE SYSTEM. ALL AREA DRAINS LOCATED IMMEDIATELY DOWNSTREAM OF THE PROJECT SHALL BE PROTECTED UNTIL COMPLETION OF THE DEMOLITION, GRADING, AND CONSTRUCTION OPERATIONS.

CONTRACTOR TO CUT AND CAP EXISTING UTILITIES (SANITARY

- STORM, ETC.) WHICH ARE TO BE ABANDONED. PERMANENT DISCONNECTION OF UTILITIES SHALL BE CARRIED OUT IN ACCORDANCE WITH THE CITY OF PHILADELPHIA WATER DEPARTMENT STANDARDS. TRENCH AND FOOTWALK RESTORATION TO BE CONDUCTED IN ACCORDANCE WITH THE
- CITY OF PHILADELPHIA DEPARTMENT OF STREETS STANDARD DETAILS AND SPECIFICATIONS. ALL DEMOLITION TO BE COMPLETED IN ACCORDANCE WITH UTILITY COMPANY AND/OR CITY REGULATIONS, WHICHEVER
- IF ANY MATERIALS SUSPECTED OF CONTAINING ASBESTOS OR OTHER HAZARDOUS MATERIALS (HYDRAULIC FLUID, ETC.) ARE ENCOUNTERED, DO NOT DISTURB THE MATERIALS. IMMEDIATELY NOTIFY THE OWNER. REMOVE EXISTING TRASH CANS, SIGNS AND OTHER SITE
- AMENITIES ASSOCIATED WITH DEMOLITION, AS REQUIRED. THIS PLAN DOES NOT SPECIFY CONSTRUCTION PHASING PRIOR TO CONSTRUCTION. THE CONTRACTOR SHALL CONSULT WITH THE OWNER FOR SPECIFIC PHASING INSTRUCTIONS.

7 ISSUED FOR CONSTRUCTION	CPN	MJC	13.12.04
6 CHILLED WATER MAINS PER 6/2/1989 PLAN	CPN	MJC	13.10.25
5 CONSTRUCTION SET	CPN	MJC	13.10.18
4 ISSUED FOR OWNER REVIEW	WMC	MJC	13.08.30
3 SUBMISSION FOR STREETS DEPARTMENT REVIEW	CPN	MJC	13.08.30
2 SUBMISSION FOR OWNER'S APPROVAL	CPN	MJC	13.05.31
1 SUBMISSION TO CCP FOR BONNELL PLAZA CONSTRUCTION	CPN	MJC	13.05.10
Issued	Ву	Appd.	YY.MM.DD

File Name: 177901252-c200.dwg Dwn. Chkd. Dsgn. YY.MM.DD Permit-Seal


Client/Project

COMMUNITY COLLEGE OF PHILADELPHIA

PAVILION AND BONNELL PLAZAS & 17TH STREET IMPROVEMENTS Philadelphia, PA

Title MODIFIED EXISTING CONDITIONS & DEMOLITION PLAN

Project No. 177901252	Scale 1"=20'	
Drawing No.	Sheet	Revision
C200	3 of 14	0

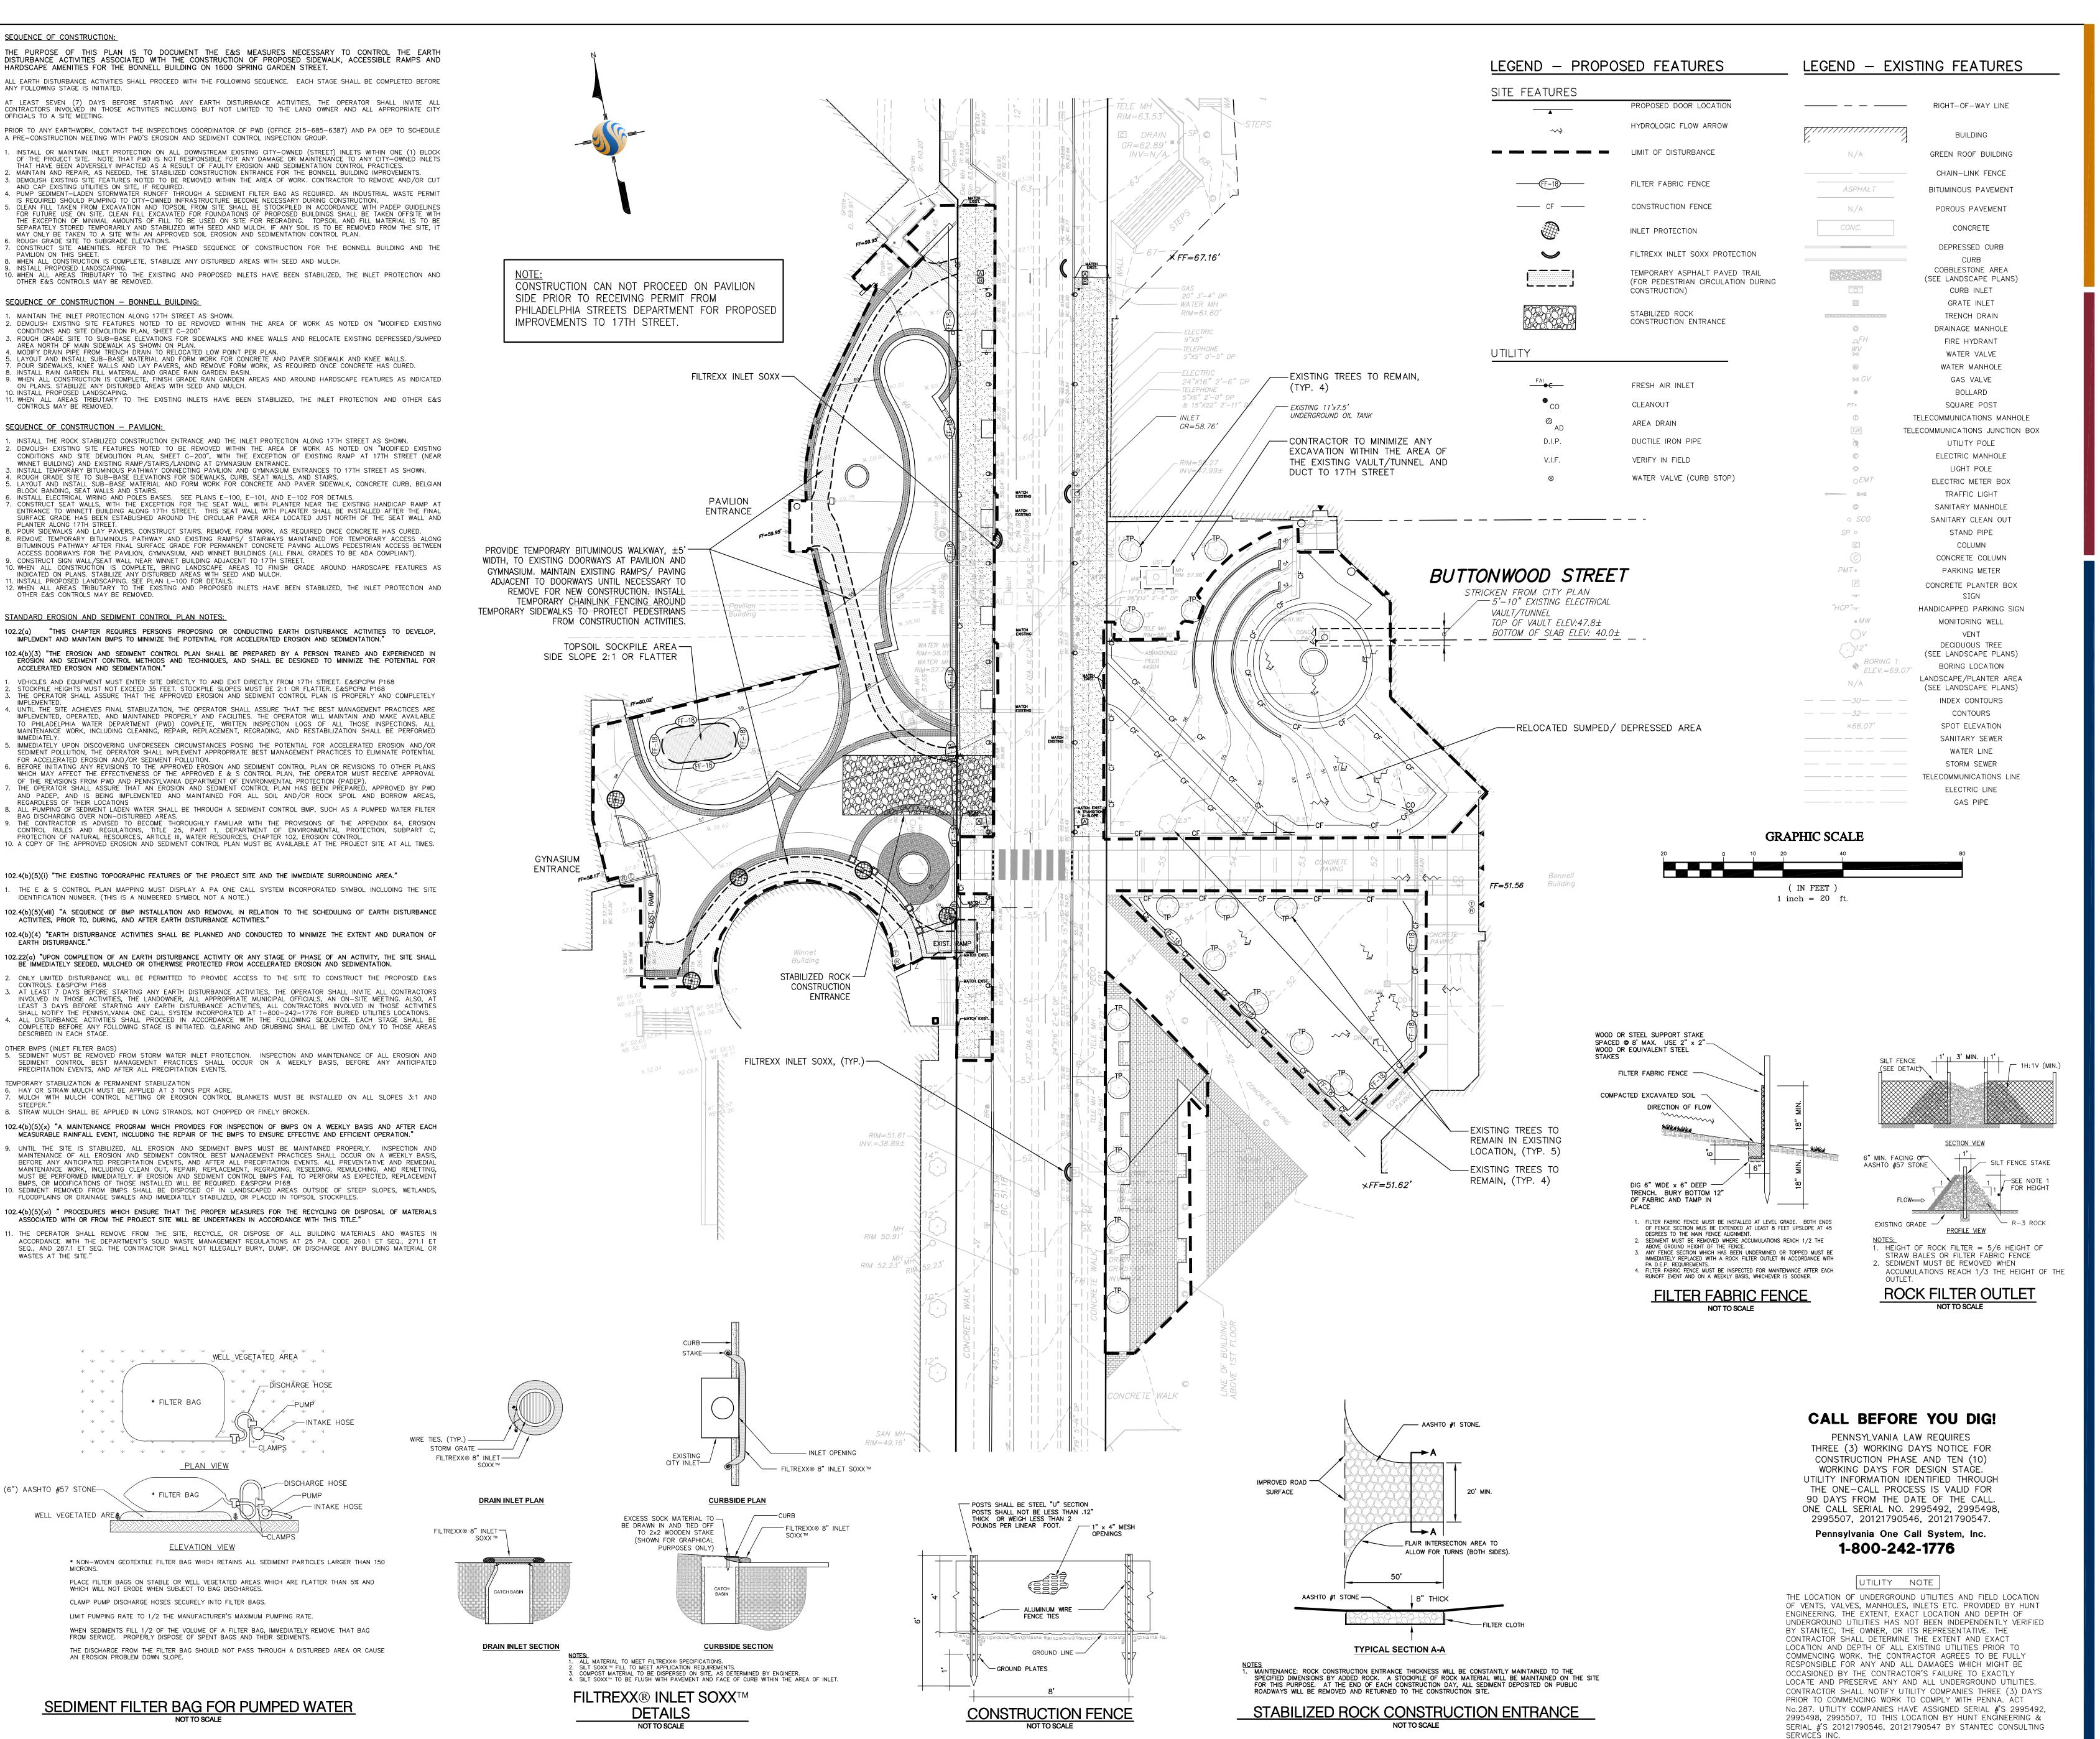



Stantec Consulting Services Inc.
1500 Spring Garden Suite 1100
Philadelphia PA 19130
Tel. 215.665.7000
Fax. 215.665.7001

Stan

Copyright Reserved


The Contractor sh

The Contractor shall verify and be responsible for all dimensions. DO NOT scale the drawing — any errors or omissions shall be reported to Stantec without delay.

The Copyrights to all designs and drawings are the property of Stantec. Reproduction or use for any purpose other than that authorized by Stantec is forbidden.

www.stantec.com

Notes

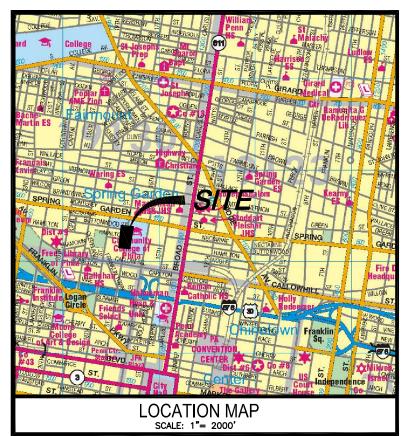

GENERAL NOTES:

1. ALL EXISTING CONDITION INFORMATION DEPICTED ON THE PLAN IS PER HUNT ENGINEERING PLANS TITLED "CIVIL EXISTING CONDITIONS - 1" AND "CIVIL EXISTING CONDITIONS - 2" DATED JUNE 12, 2009. THE PLAN HAS BEEN AMENDED BY STANTEC CONSULTING SERVICES INC. THROUGH THE INCLUSION OF THE EXISTING UNDERGROUND ELECTRIC VAULT AND OIL TANK WHICH ARE SITUATED WITHIN THE BONNELL PLAZA ANEX. THE INFORMATION IS REFERENCED FROM PLAN TITLED 'GROUND FLOOR PLAN SOUTH 'C" BY THE KLING PARTNERSHIP DATED NOVEMBER 30, 1979 AND "DETAILS & DIAGRAMS SOUTH MINT WEST" BY THE KLING PARTNERSHIP DATED NOVEMBER 30, 1979 AND LAST REVISED SEPTEMBER 1, 1982. BENCHMARK IS CALLED OUT ON THE HUNT ENGINEERING PLANS NOTED ABOVE AT THE FOLLOWING LOCATION: 17TH STREET AND SPRING GARDEN STREET, SOUTHWEST CORNER OF INTERSECTION, EAST END OF LOWEST GRANITE STEP AT THE MAIN ENTRANCE TO LIBRARY, ELEVATION 68.28. ATTENTION IS CALLED TO THE PHILADELPHIA ZONING CODE AS AMENDED. PROPERTY IS ZONED IDD. SUBJECT PREMISES DOES NOT LIE WITHIN A FLOOD HAZARD AREA. SUBJECT PREMISES IS AN AREA "X" AS PER FEDERAL EMERGENCY

SHOULD ANY DISCREPANCIES BE FOUND WITH EXISTING FEATURES DURING CONSTRUCTION, THE CONTRACTOR SHALL REMEDY THE DISCREPANCY WITH THE OWNER OR THE OWNER'S SURVEYOR (HUNT ENGINEERING).

7. ALL PROPOSED UTILITY SERVICES WILL BE UNDERGROUND OR WILL ENTER PROPOSED PROPERTY FROM THE PUBLIC RIGHT—OF—WAY.

8. THE CONTRACTOR SHALL CONFORM TO ALL THE REQUIREMENTS OF PA ACT 187 AS AMENDED.

9. REFER TO PLAN TITLED "CIVIL EROSION AND SEDIMENT CONTROL PLAN" AND "CIVIL DETAILS — 2" DATED SEPTEMBER 23, 2009 BY HUNT

MANAGEMENT AGENCY FLOOD INSURANCE MAP COMMUNITY PANEL

UTILITIES ENTER THE PREMISES FROM PUBLIC STREETS OR RIGHT OF WAY.
NO ADDITIONAL FIELD SURVEY OR EXISTING UTILITY RESEARCH FOR PUBLIC

UTILITIES HAS BEEN PERFORMED BY STANTEC CONSULTING SERVICES INC

420757-0183G, LAST REVISED JANUARY 17, 2007

ENGINEERING FOR THE APPROVED EROSION AND SEDIMENT CONTROL PLAN FOR NPDES APPLICATION.

NOTE:

CONTRACTOR TO PERFORM ALL WORK IN ACCORDANCE WITH THE

NPDES PERMIT AND EROSION & SEDIMENTATION CONTROL PLANS PREVIOUSLY APPROVED FOR THIS PROJECT. FOR CONSTRUCTION OF THE FINAL HARDSCAPE/SOFTSCAPE AREAS ADJACENT TO THE BONNELL BUILDING & PAVILION, IT IS ANTICIPATED THAT CONSTRUCTION VEHICLE TRAFFIC WILL BE LIMITED TO SMALLER LIGHT DUTY VEHICLES. SINCE THESE AREAS ARE LOWER THAN THE ELEVATION OF THE PUBLIC SIDEWALK ALONG 17TH STREET, THE INSTALLATION OF A ROCK CONSTRUCTION ENTRANCE WILL NOT BE NEEDED. INSTEAD, THE CONTRACTOR SHALL BE REQUIRED TO MAINTAIN A VEHICULAR WASH—DOWN AREA FOR CONSTRUCTION EQUIPMENT LEAVING THE SITE

7 ISSUED FOR CONSTRUCTION	CPN	MJC	13.12.04
6 CHILLED WATER MAINS PER 6/2/1989 PLAN	CPN	MJC	13.10.25
5 CONSTRUCTION SET	CPN	MJC	13.10.18
4 ISSUED FOR OWNER REVIEW	WMC	MJC	13.08.30
3 SUBMISSION FOR STREETS DEPARTMENT REVIEW	CPN	MJC	13.08.30
2 SUBMISSION FOR OWNER'S APPROVAL	CPN	MJC	13.05.31
1 SUBMISSION TO CCP FOR BONNELL PLAZA CONSTRUCTION	CPN	MJC	13.05.10
Issued	Ву	Appd.	YY.MM.DD

 File Name:
 177901252-c300.dwg
 LDL
 MJC
 MJC
 2013.02.04

 Dwn.
 Chkd.
 Dsgn.
 YY.MM.DD

Client/Project

COMMUNITY COLLEGE
OF PHILADELPHIA


PAVILION AND BONNELL PLAZAS & 17TH STREET IMPROVEMENTS Philadelphia, PA


EROSION & SEDIMENT CONTROL PLAN

Project No. Scale 1"=20'

Drawing No. Sheet Revision

C300 4 of 14 0

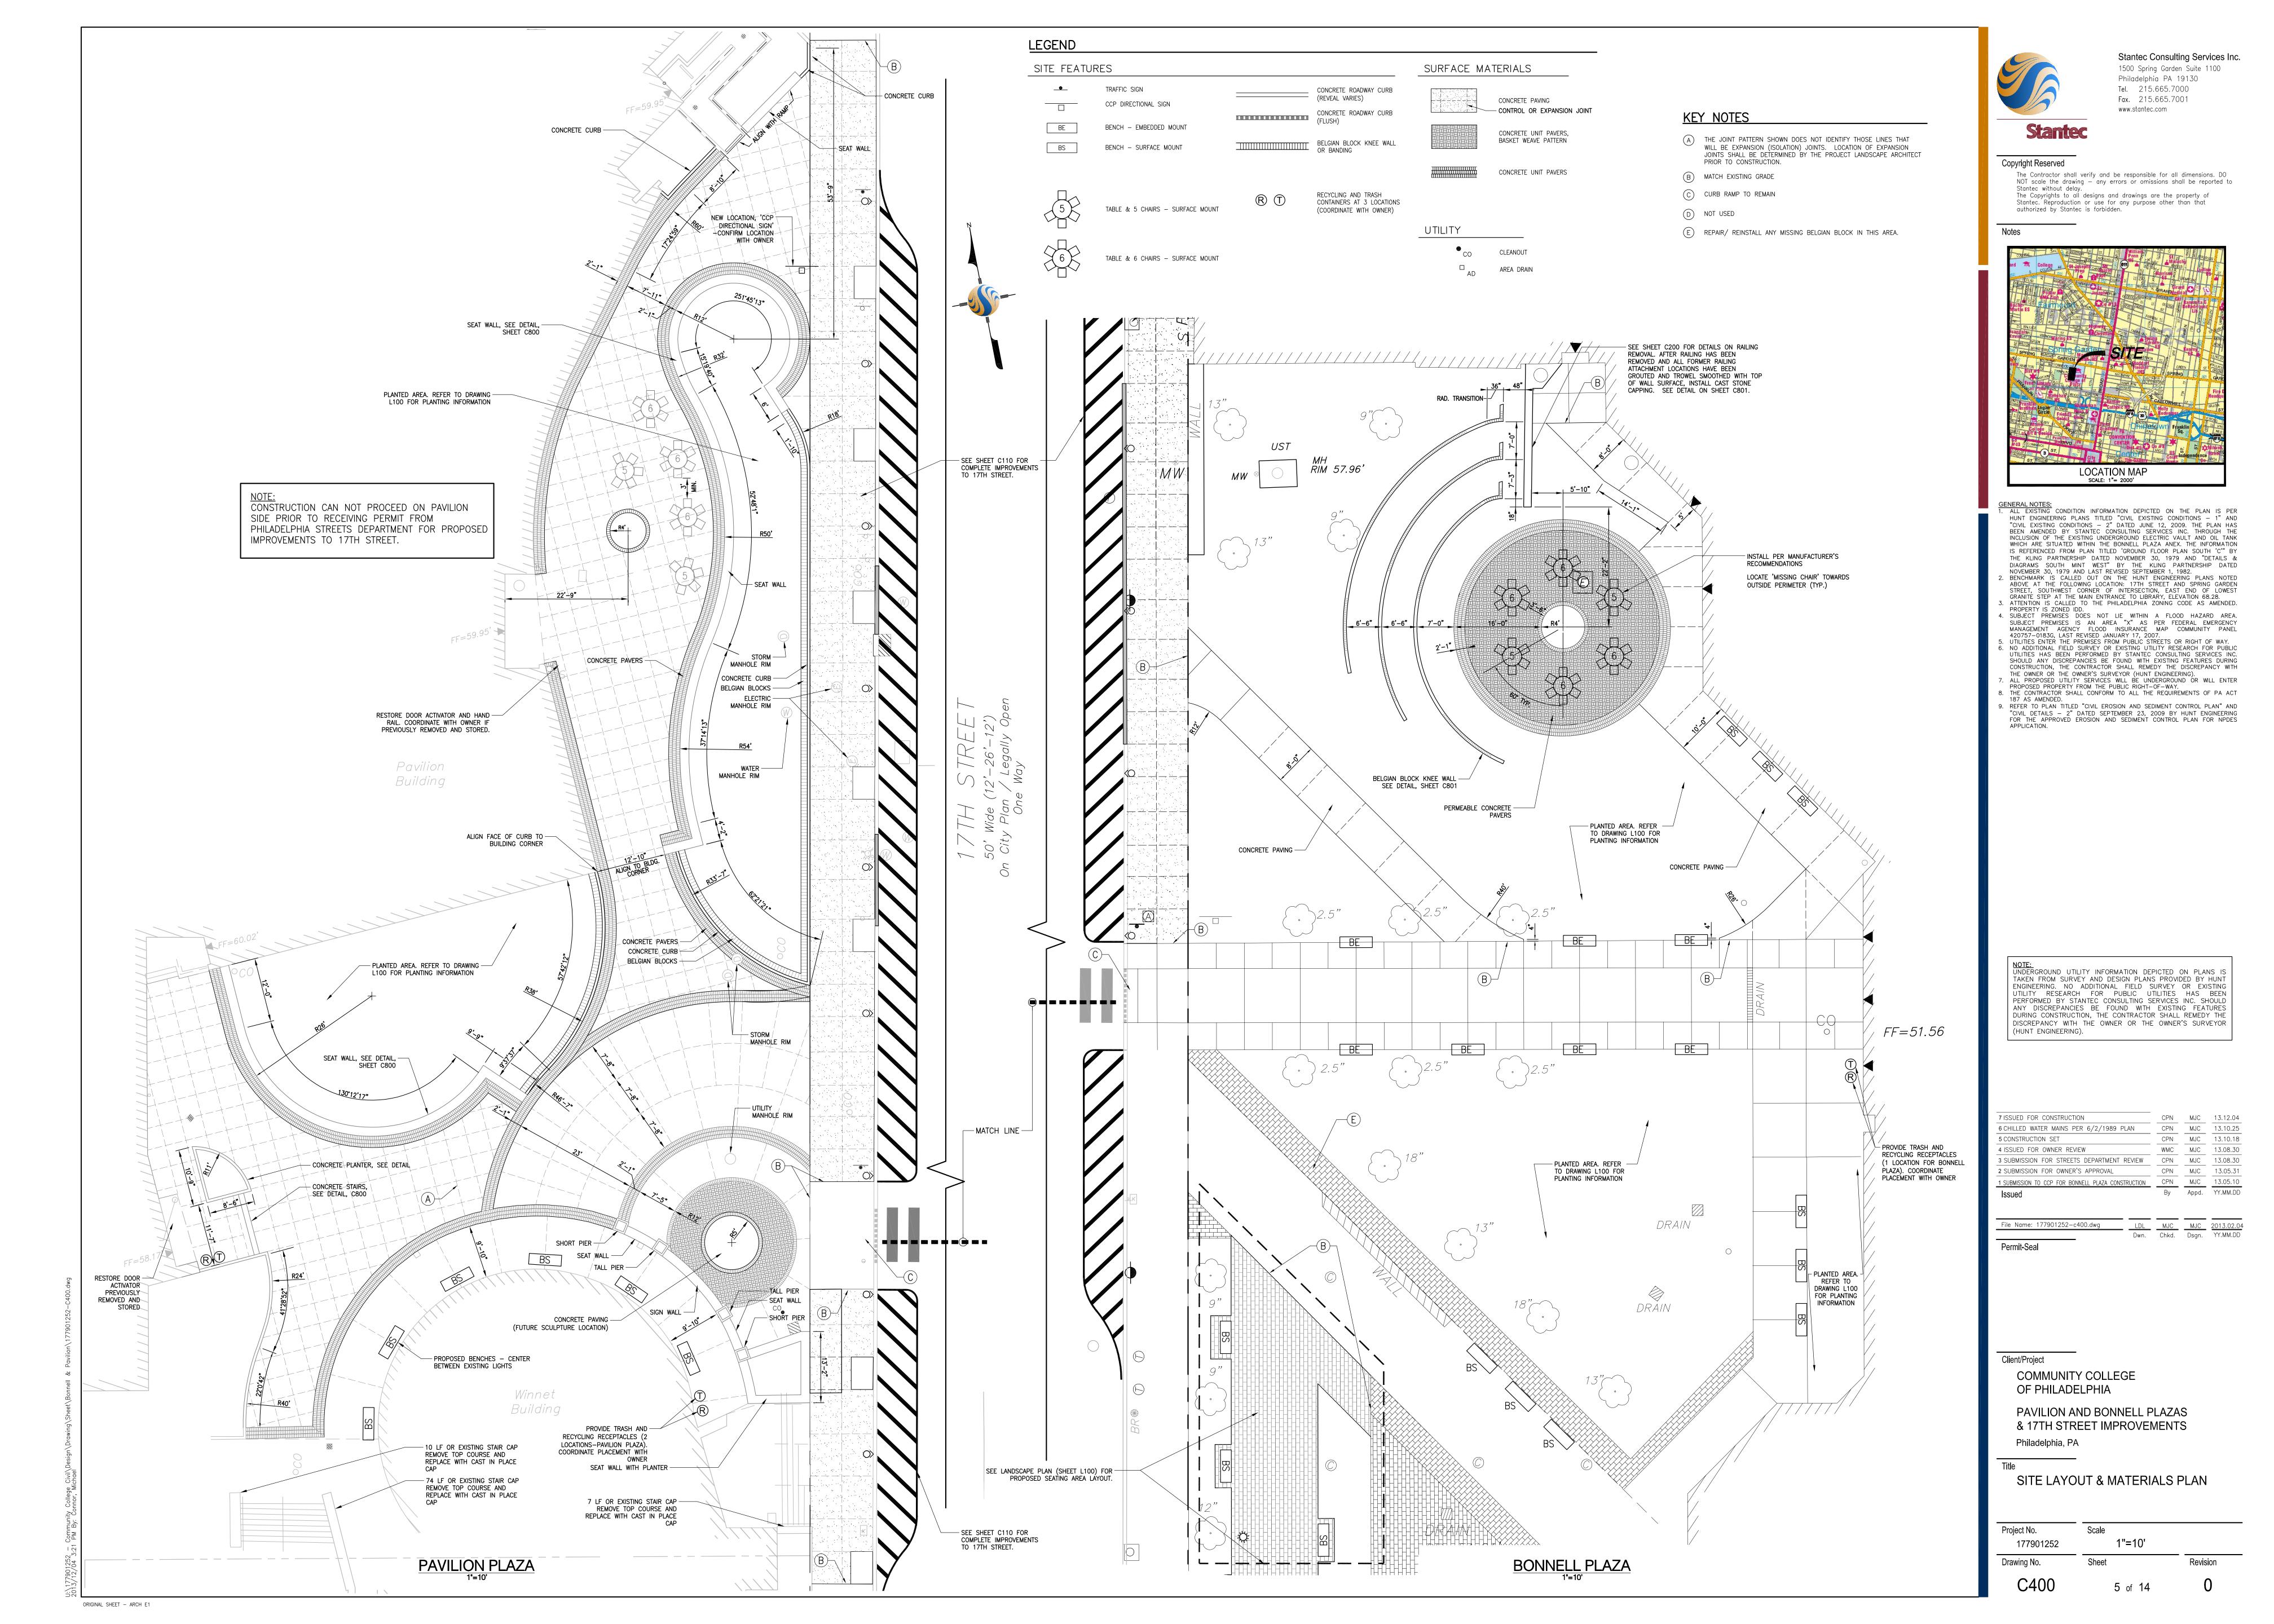

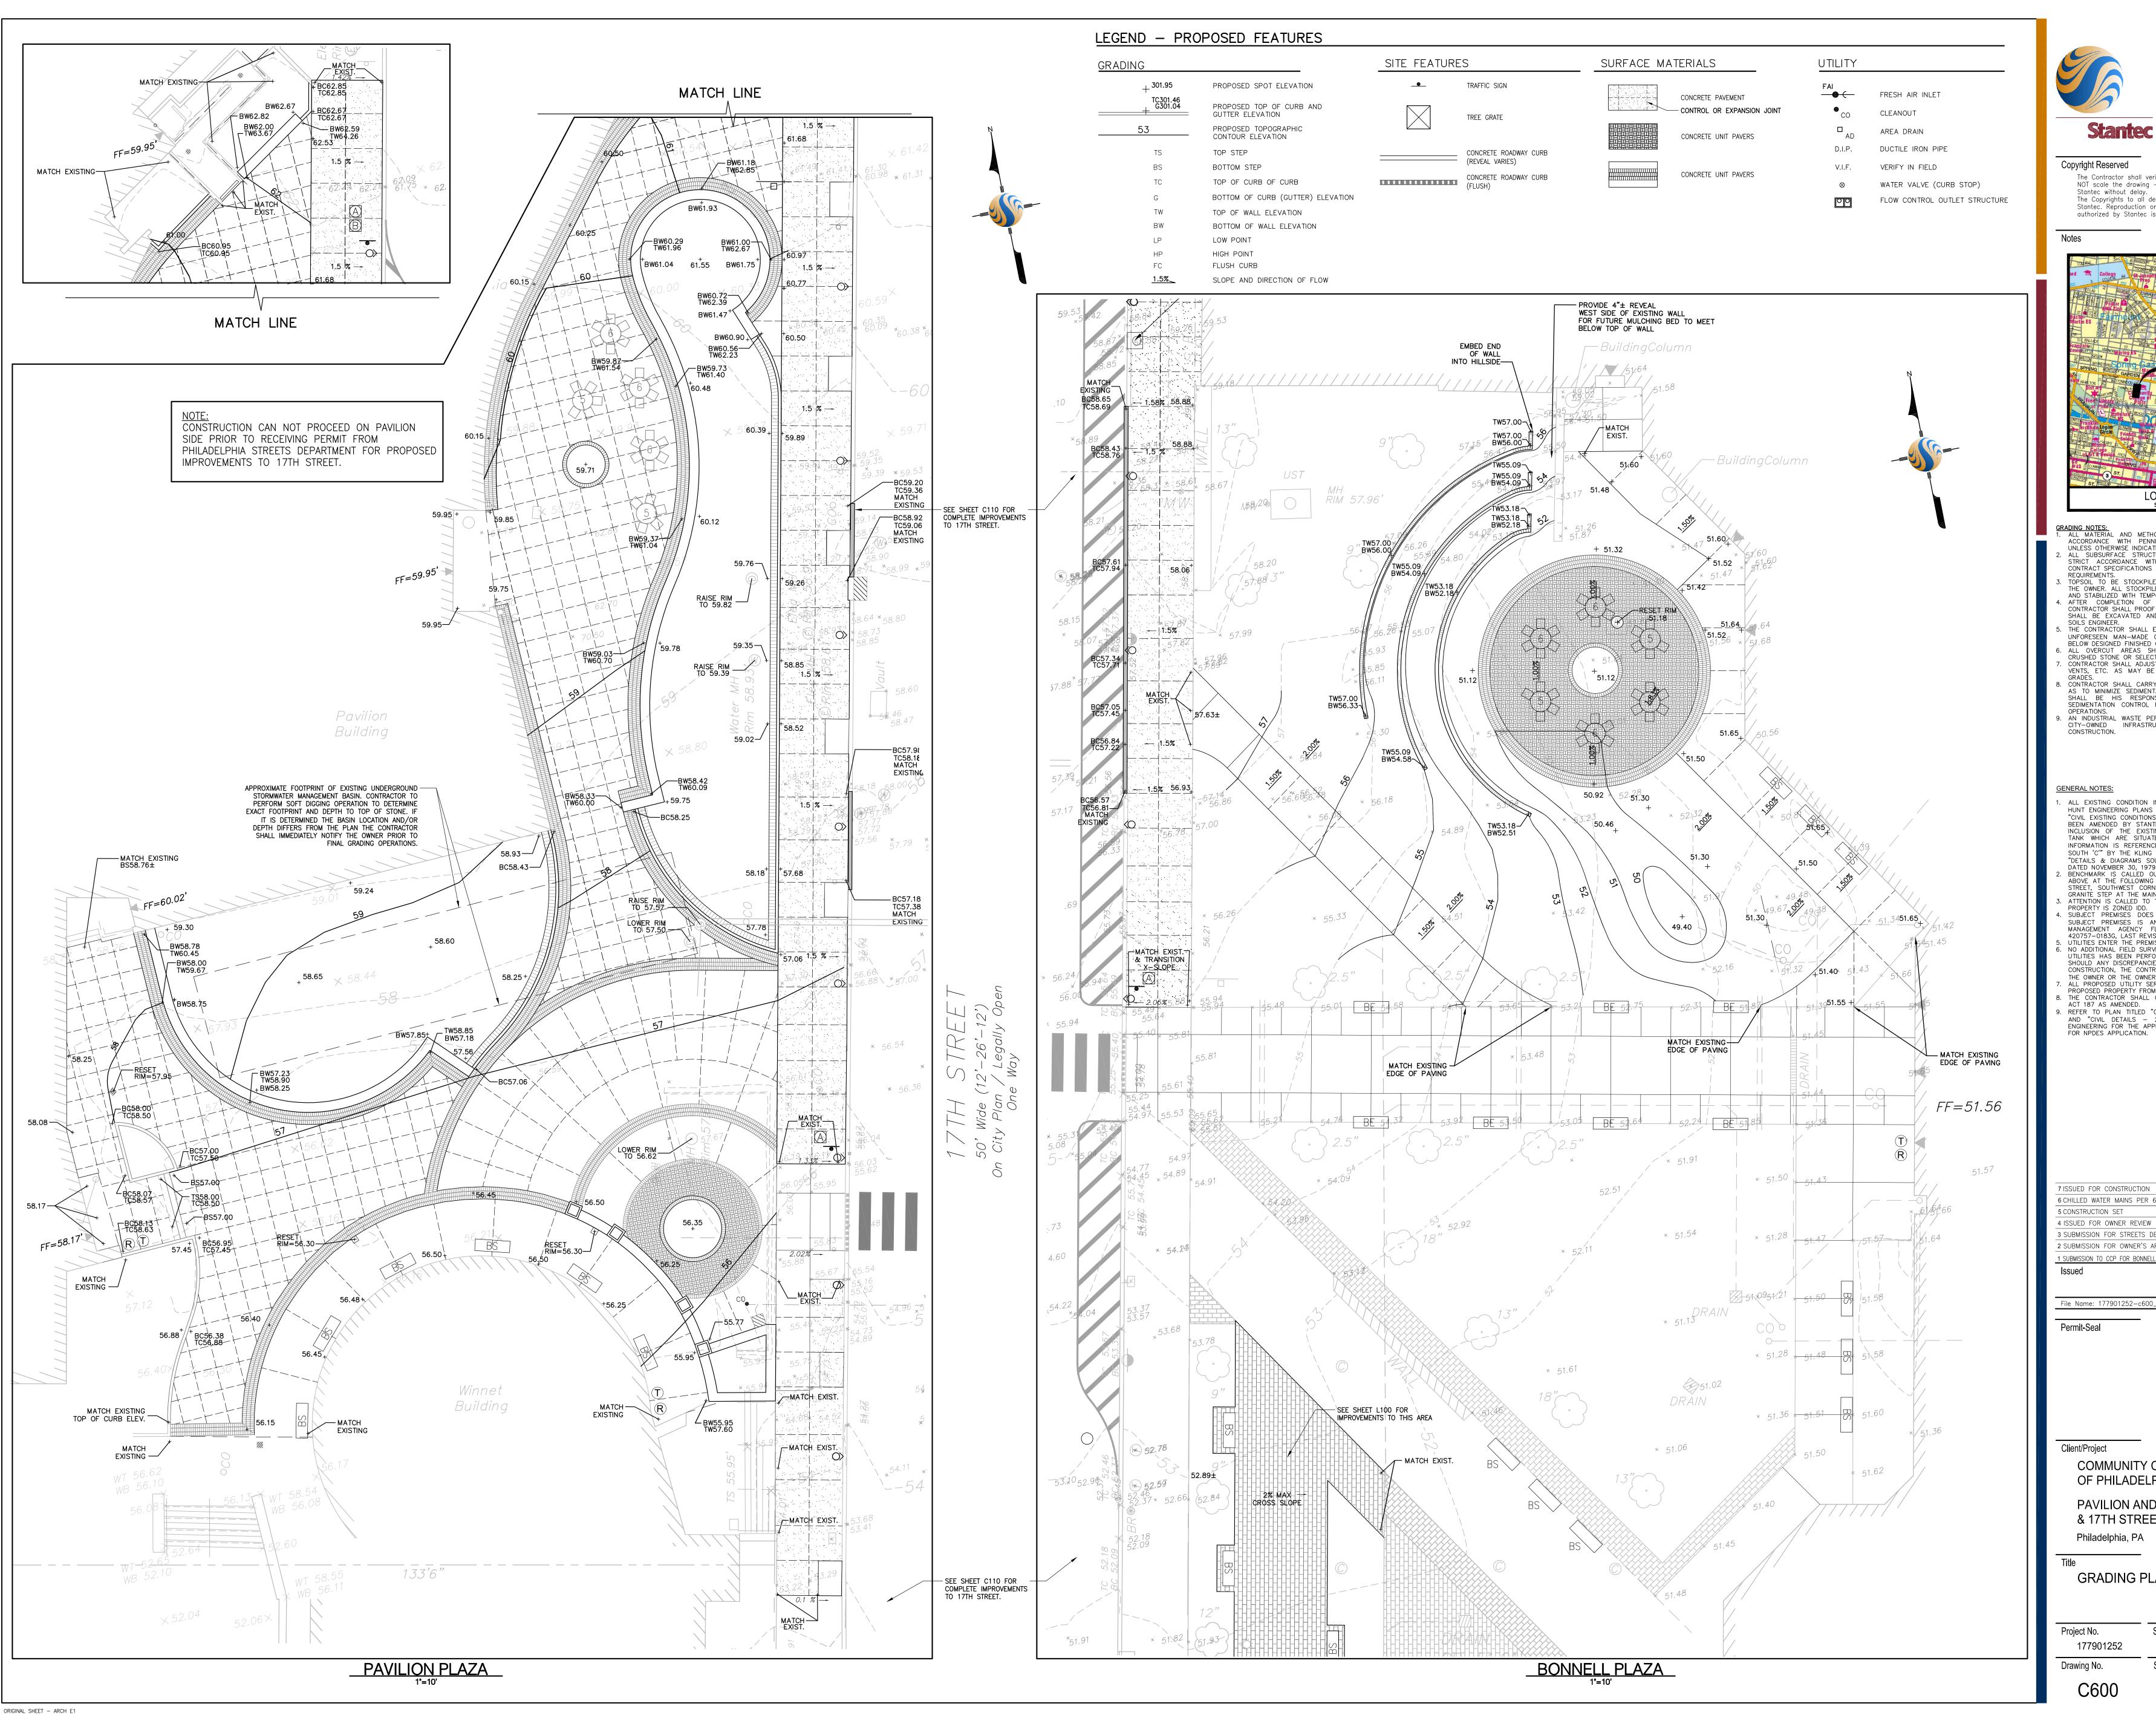



Stantec Consulting Services Inc. 1500 Spring Garden Suite 1100 Philadelphia PA 19130 Tel. 215.665.7000


Fax. 215.665.7001

www.stantec.com

Stantec

Copyright Reserved

The Contractor shall verify and be responsible for all dimensions. DO NOT scale the drawing — any errors or omissions shall be reported to Stantec without delay. The Copyrights to all designs and drawings are the property of Stantec. Reproduction or use for any purpose other than that authorized by Stantec is forbidden.

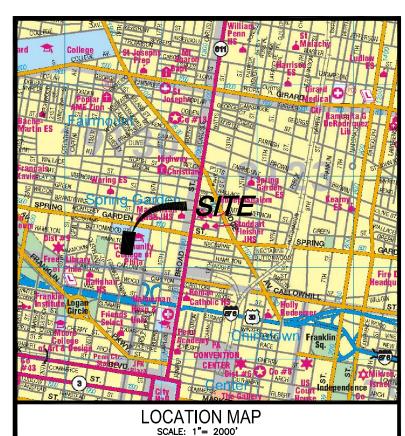

GRADING NOTES:

1. ALL MATERIAL AND METHODS OF CONSTRUCTION SHALL BE IN STRICT ACCORDANCE WITH PENNDOT FORM 408 STANDARD SPECIFICATIONS UNLESS OTHERWISE INDICATED.

ALL SUBSURFACE STRUCTURE EXCAVATION SHALL BE CONDUCTED IN STRICT ACCORDANCE WITH THE APPROPRIATE SECTIONS OF THE CONTRACT SPECIFICATIONS AND WITH OSHA 1926.651 SPECIAL EXCAVATION TOPSOIL TO BE STOCKPILED ON—SITE SHALL BE AT THE DIRECTION OF THE OWNER. ALL STOCKPILED MATERIAL SHALL BE GRADED, COMPACTED AND STABILIZED WITH TEMPORARY SEEDING AND MULCHING. AFTER COMPLETION OF THE ROUGH GRADING OPERATIONS, THE CONTRACTOR SHALL PROOF ROLL THE PAVEMENT AREA. SOFT SPOTS SHALL BE EXCAVATED AND STABILIZED UNDER THE SUPERVISION OF A THE CONTRACTOR SHALL EXCAVATE OLD WALLS, FOUNDATIONS AND LIKE UNFORESEEN MAN-MADE OBSTRUCTIONS TO A LEVEL THREE (3) FEET BELOW DESIGNED FINISHED GRADE. ALL OVERCUT AREAS SHALL BE BROUGHT BACK TO GRADE USING CRUSHED STONE OR SELECT BACKFILL MATERIAL.

CONTRACTOR SHALL ADJUST MANHOLE LIDS, INLET GRATES, VALVE BOXES, VENTS, ETC. AS MAY BE REQUIRED TO MATCH THE DESIGNED FINISH GRADES.
CONTRACTOR SHALL CARRY OUT THE GRADING OPERATION IN SUCH WAY
AS TO MINIMIZE SEDIMENTATION OF THE ADJACENT STORM SYSTEM. IT
SHALL BE HIS RESPONSIBILITY TO IMPLEMENT AND MAINTAIN A
SEDIMENTATION CONTROL PLAN FOR THE DURATION OF THE GRADING AN INDUSTRIAL WASTE PERMIT WILL BE REQUIRED SHOULD PUMPING TO CITY—OWNED INFRASTRUCTURE BECOME NECESSARY DURING CONSTRUCTION.

GENERAL NOTES:

. ALL EXISTING CONDITION INFORMATION DEPICTED ON THE PLAN IS PER HUNT ENGINEERING PLANS TITLED "CIVIL EXISTING CONDITIONS - 1" AND HUNT ENGINEERING PLANS TITLED "CIVIL EXISTING CONDITIONS — 1" AND "CIVIL EXISTING CONDITIONS — 2" DATED JUNE 12, 2009. THE PLAN HAS BEEN AMENDED BY STANTEC CONSULTING SERVICES INC. THROUGH THE INCLUSION OF THE EXISTING UNDERGROUND ELECTRIC VAULT AND OIL TANK WHICH ARE SITUATED WITHIN THE BONNELL PLAZA ANEX. THE INFORMATION IS REFERENCED FROM PLAN TITLED 'GROUND FLOOR PLAN SOUTH 'C'" BY THE KLING PARTNERSHIP DATED NOVEMBER 30, 1979 AND "DETAILS & DIAGRAMS SOUTH MINT WEST" BY THE KLING PARTNERSHIP DATED NOVEMBER 30, 1979 AND LAST REVISED SEPTEMBER 1, 1982.

2. BENCHMARK IS CALLED OUT ON THE HUNT ENGINEERING PLANS NOTED ABOVE AT THE FOLLOWING LOCATION: 17TH STREET AND SPRING GARDEN STREET, SOUTHWEST CORNER OF INTERSECTION, EAST END OF LOWEST GRANITE STEP AT THE MAIN ENTRANCE TO LIBRARY, ELEVATION 68.28. GRANITE STEP AT THE MAIN ENTRANCE TO LIBRARY, ELEVATION 68.28.

3. ATTENTION IS CALLED TO THE PHILADELPHIA ZONING CODE AS AMENDED. PROPERTY IS ZONED IDD.

4. SUBJECT PREMISES DOES NOT LIE WITHIN A FLOOD HAZARD AREA. SUBJECT PREMISES IS AN AREA "X" AS PER FEDERAL EMERGENCY MANAGEMENT AGENCY FLOOD INSURANCE MAP COMMUNITY PANEL MANAGEMEN I AGENCY FLOOD INSURANCE MAP COMMUNITY PANEL 420757—0183G, LAST REVISED JANUARY 17, 2007.

5. UTILITIES ENTER THE PREMISES FROM PUBLIC STREETS OR RIGHT OF WAY.

6. NO ADDITIONAL FIELD SURVEY OR EXISTING UTILITY RESEARCH FOR PUBLIC UTILITIES HAS BEEN PERFORMED BY STANTEC CONSULTING SERVICES INC. SHOULD ANY DISCREPANCIES BE FOUND WITH EXISTING FEATURES DURING CONSTRUCTION, THE CONTRACTOR SHALL REMEDY THE DISCREPANCY WITH THE OWNER OR THE OWNER'S SURVEYOR (HUNT ENGINEERING). ALL PROPOSED UTILITY SERVICES WILL BE UNDERGROUND OR WILL ENTER PROPOSED PROPERTY FROM THE PUBLIC RIGHT—OF—WAY.

THE CONTRACTOR SHALL CONFORM TO ALL THE REQUIREMENTS OF PA ACT 187 AS AMENDED. ACT 167 AS AMENDED.

2. REFER TO PLAN TITLED "CIVIL EROSION AND SEDIMENT CONTROL PLAN"

AND "CIVIL DETAILS — 2" DATED SEPTEMBER 23, 2009 BY HUNT

ENGINEERING FOR THE APPROVED EROSION AND SEDIMENT CONTROL PLAN

7 ISSUED FOR CONSTRUCTION	CPN	MJC	13.12.04
6 CHILLED WATER MAINS PER 6/2/1989 PLAN	CPN	MJC	13.10.25
5 CONSTRUCTION SET	CPN	MJC	13.10.18
4 ISSUED FOR OWNER REVIEW	WMC	MJC	13.08.30
3 SUBMISSION FOR STREETS DEPARTMENT REVIEW	CPN	MJC	13.08.30
2 SUBMISSION FOR OWNER'S APPROVAL	CPN	MJC	13.05.31
1 SUBMISSION TO CCP FOR BONNELL PLAZA CONSTRUCTION	CPN	MJC	13.05.10
Issued	Ву	Appd.	YY.MM.DD

 File Name:
 177901252-c600_recover.dwg
 LDL
 MJC
 LDL
 2013.02.04

 Dwn.
 Chkd.
 Dsgn.
 YY.MM.DD
 Permit-Seal


Client/Project

COMMUNITY COLLEGE OF PHILADELPHIA

PAVILION AND BONNELL PLAZAS **& 17TH STREET IMPROVEMENTS** Philadelphia, PA

GRADING PLAN

Project No. 177901252	Scale 1"=10'	
Drawing No.	Sheet	Revision
C600	6 of 14	0

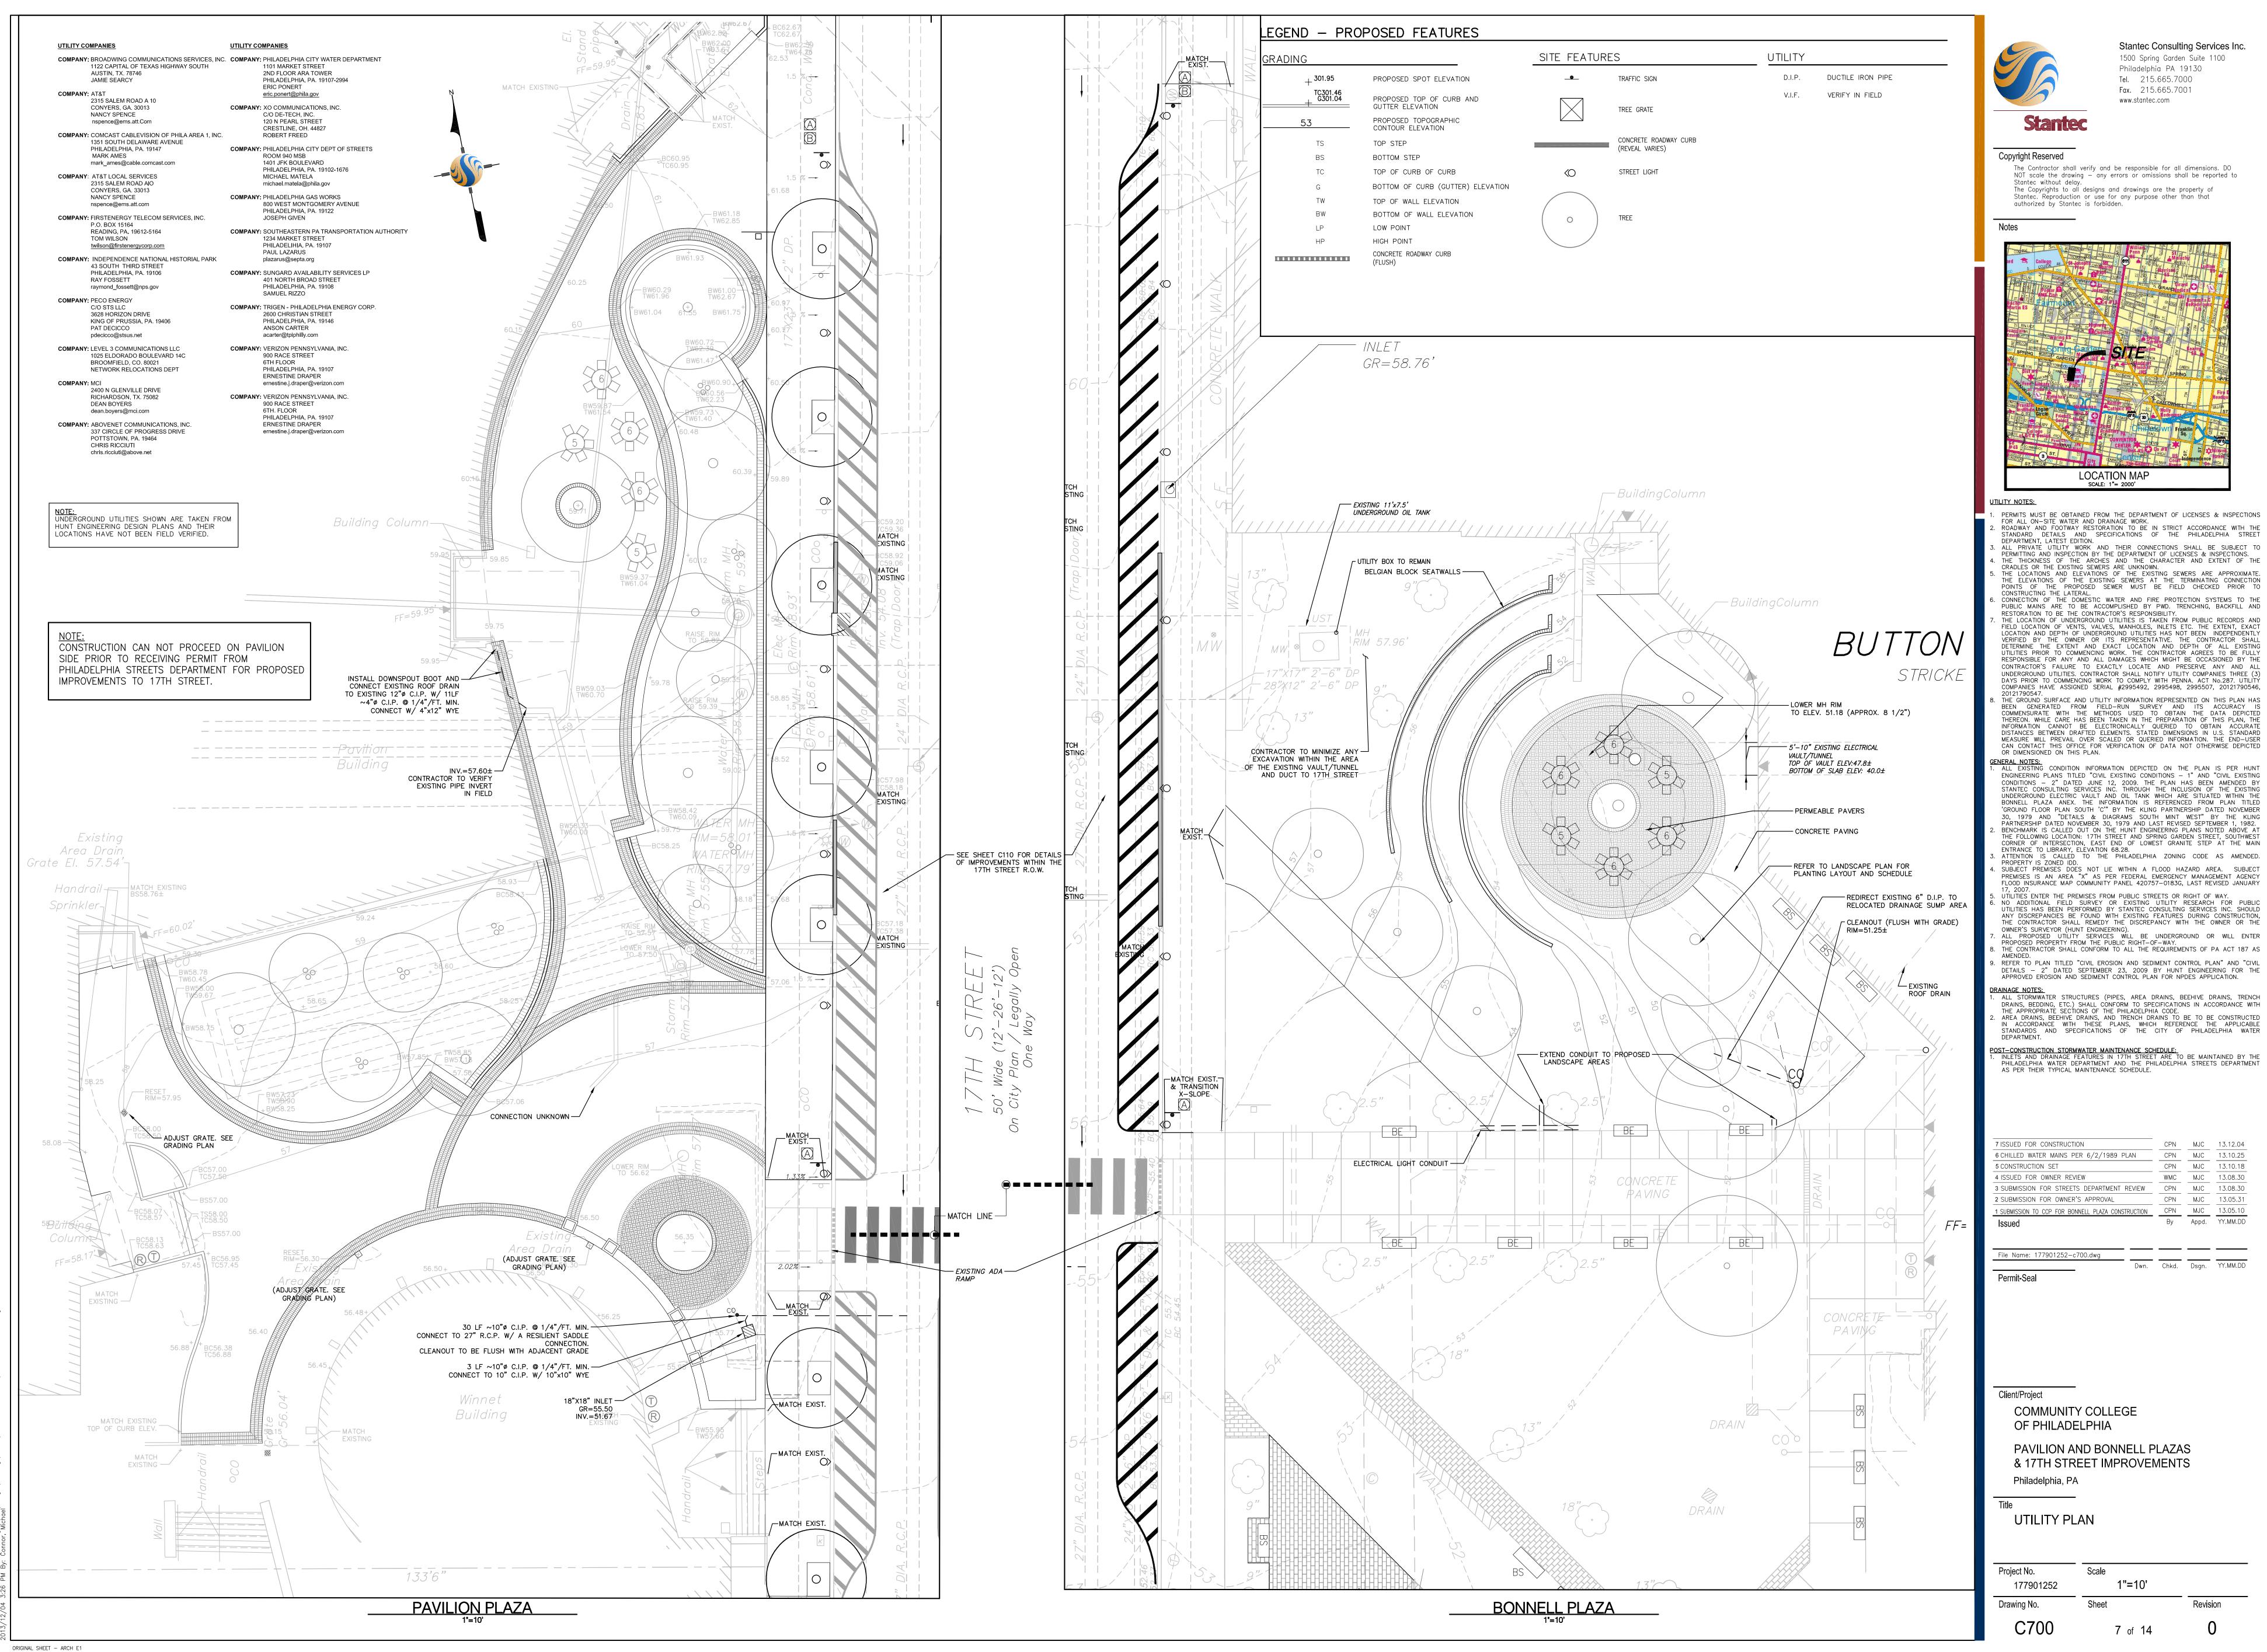

ENGINEERING PLANS TITLED "CIVIL EXISTING CONDITIONS - 1" AND "CIVIL EXISTING CONDITIONS - 2" DATED JUNE 12, 2009. THE PLAN HAS BEEN AMENDED BY STANTEC CONSULTING SERVICES INC. THROUGH THE INCLUSION OF THE EXISTING UNDERGROUND ELECTRIC VAULT AND OIL TANK WHICH ARE SITUATED WITHIN THE BONNELL PLAZA ANEX. THE INFORMATION IS REFERENCED FROM PLAN TITLED 'GROUND FLOOR PLAN SOUTH 'C'" BY THE KLING PARTNERSHIP DATED NOVEMBER). 1979 AND "DETAILS & DIAGRAMS SOUTH MINT WEST" BY THE KLING 30, 1979 AND DETAILS & DIAGRAMS SOUTH MINT WEST BY THE KLING PARTNERSHIP DATED NOVEMBER 30, 1979 AND LAST REVISED SEPTEMBER 1, 1982.

BENCHMARK IS CALLED OUT ON THE HUNT ENGINEERING PLANS NOTED ABOVE AT THE FOLLOWING LOCATION: 17TH STREET AND SPRING GARDEN STREET, SOUTHWEST CORNER OF INTERSECTION, EAST END OF LOWEST GRANITE STEP AT THE MAIN ENTRANCE TO LIBRARY, ELEVATION 68.28.


ATTENTION IS CALLED TO THE PHILADELPHIA ZONING CODE AS AMENDED.

UTILITIES ENTER THE PREMISES FROM PUBLIC STREETS OR RIGHT OF WAY.

NO ADDITIONAL FIELD SURVEY OR EXISTING UTILITY RESEARCH FOR PUBLIC UTILITIES HAS BEEN PERFORMED BY STANTEC CONSULTING SERVICES INC. SHOULD ANY DISCREPANCIES BE FOUND WITH EXISTING FEATURES DURING CONSTRUCTION, THE CONTRACTOR SHALL REMEDY THE DISCREPANCY WITH THE OWNER OR THE OWNER'S SURVEYOR (HUNT ENGINEERING). ALL PROPOSED UTILITY SERVICES WILL BE UNDERGROUND OR WILL ENTER PROPOSED PROPERTY FROM THE PUBLIC RIGHT—OF—WAY. THE CONTRACTOR SHALL CONFORM TO ALL THE REQUIREMENTS OF PA ACT 187 AS

DRAINS, BEDDING, ETC.) SHALL CONFORM TO SPECIFICATIONS IN ACCORDANCE WITH THE APPROPRIATE SECTIONS OF THE PHILADELPHIA CODE. AREA DRAINS, BEEHIVE DRAINS, AND TRENCH DRAINS TO BE TO BE CONSTRUCTED IN ACCORDANCE WITH THESE PLANS, WHICH REFERENCE THE APPLICABLE STANDARDS AND SPECIFICATIONS OF THE CITY OF PHILADELPHIA WATER

7 ISSUED FOR CONSTRUCTION	CPN	MJC	13.12.04
6 CHILLED WATER MAINS PER 6/2/1989 PLAN	CPN	MJC	13.10.25
5 CONSTRUCTION SET	CPN	MJC	13.10.18
4 ISSUED FOR OWNER REVIEW	WMC	MJC	13.08.30
3 SUBMISSION FOR STREETS DEPARTMENT REVIEW	CPN	MJC	13.08.30
2 SUBMISSION FOR OWNER'S APPROVAL	CPN	MJC	13.05.31
1 SUBMISSION TO CCP FOR BONNELL PLAZA CONSTRUCTION	CPN	MJC	13.05.10
Issued	Ву	Appd.	YY.MM.DD

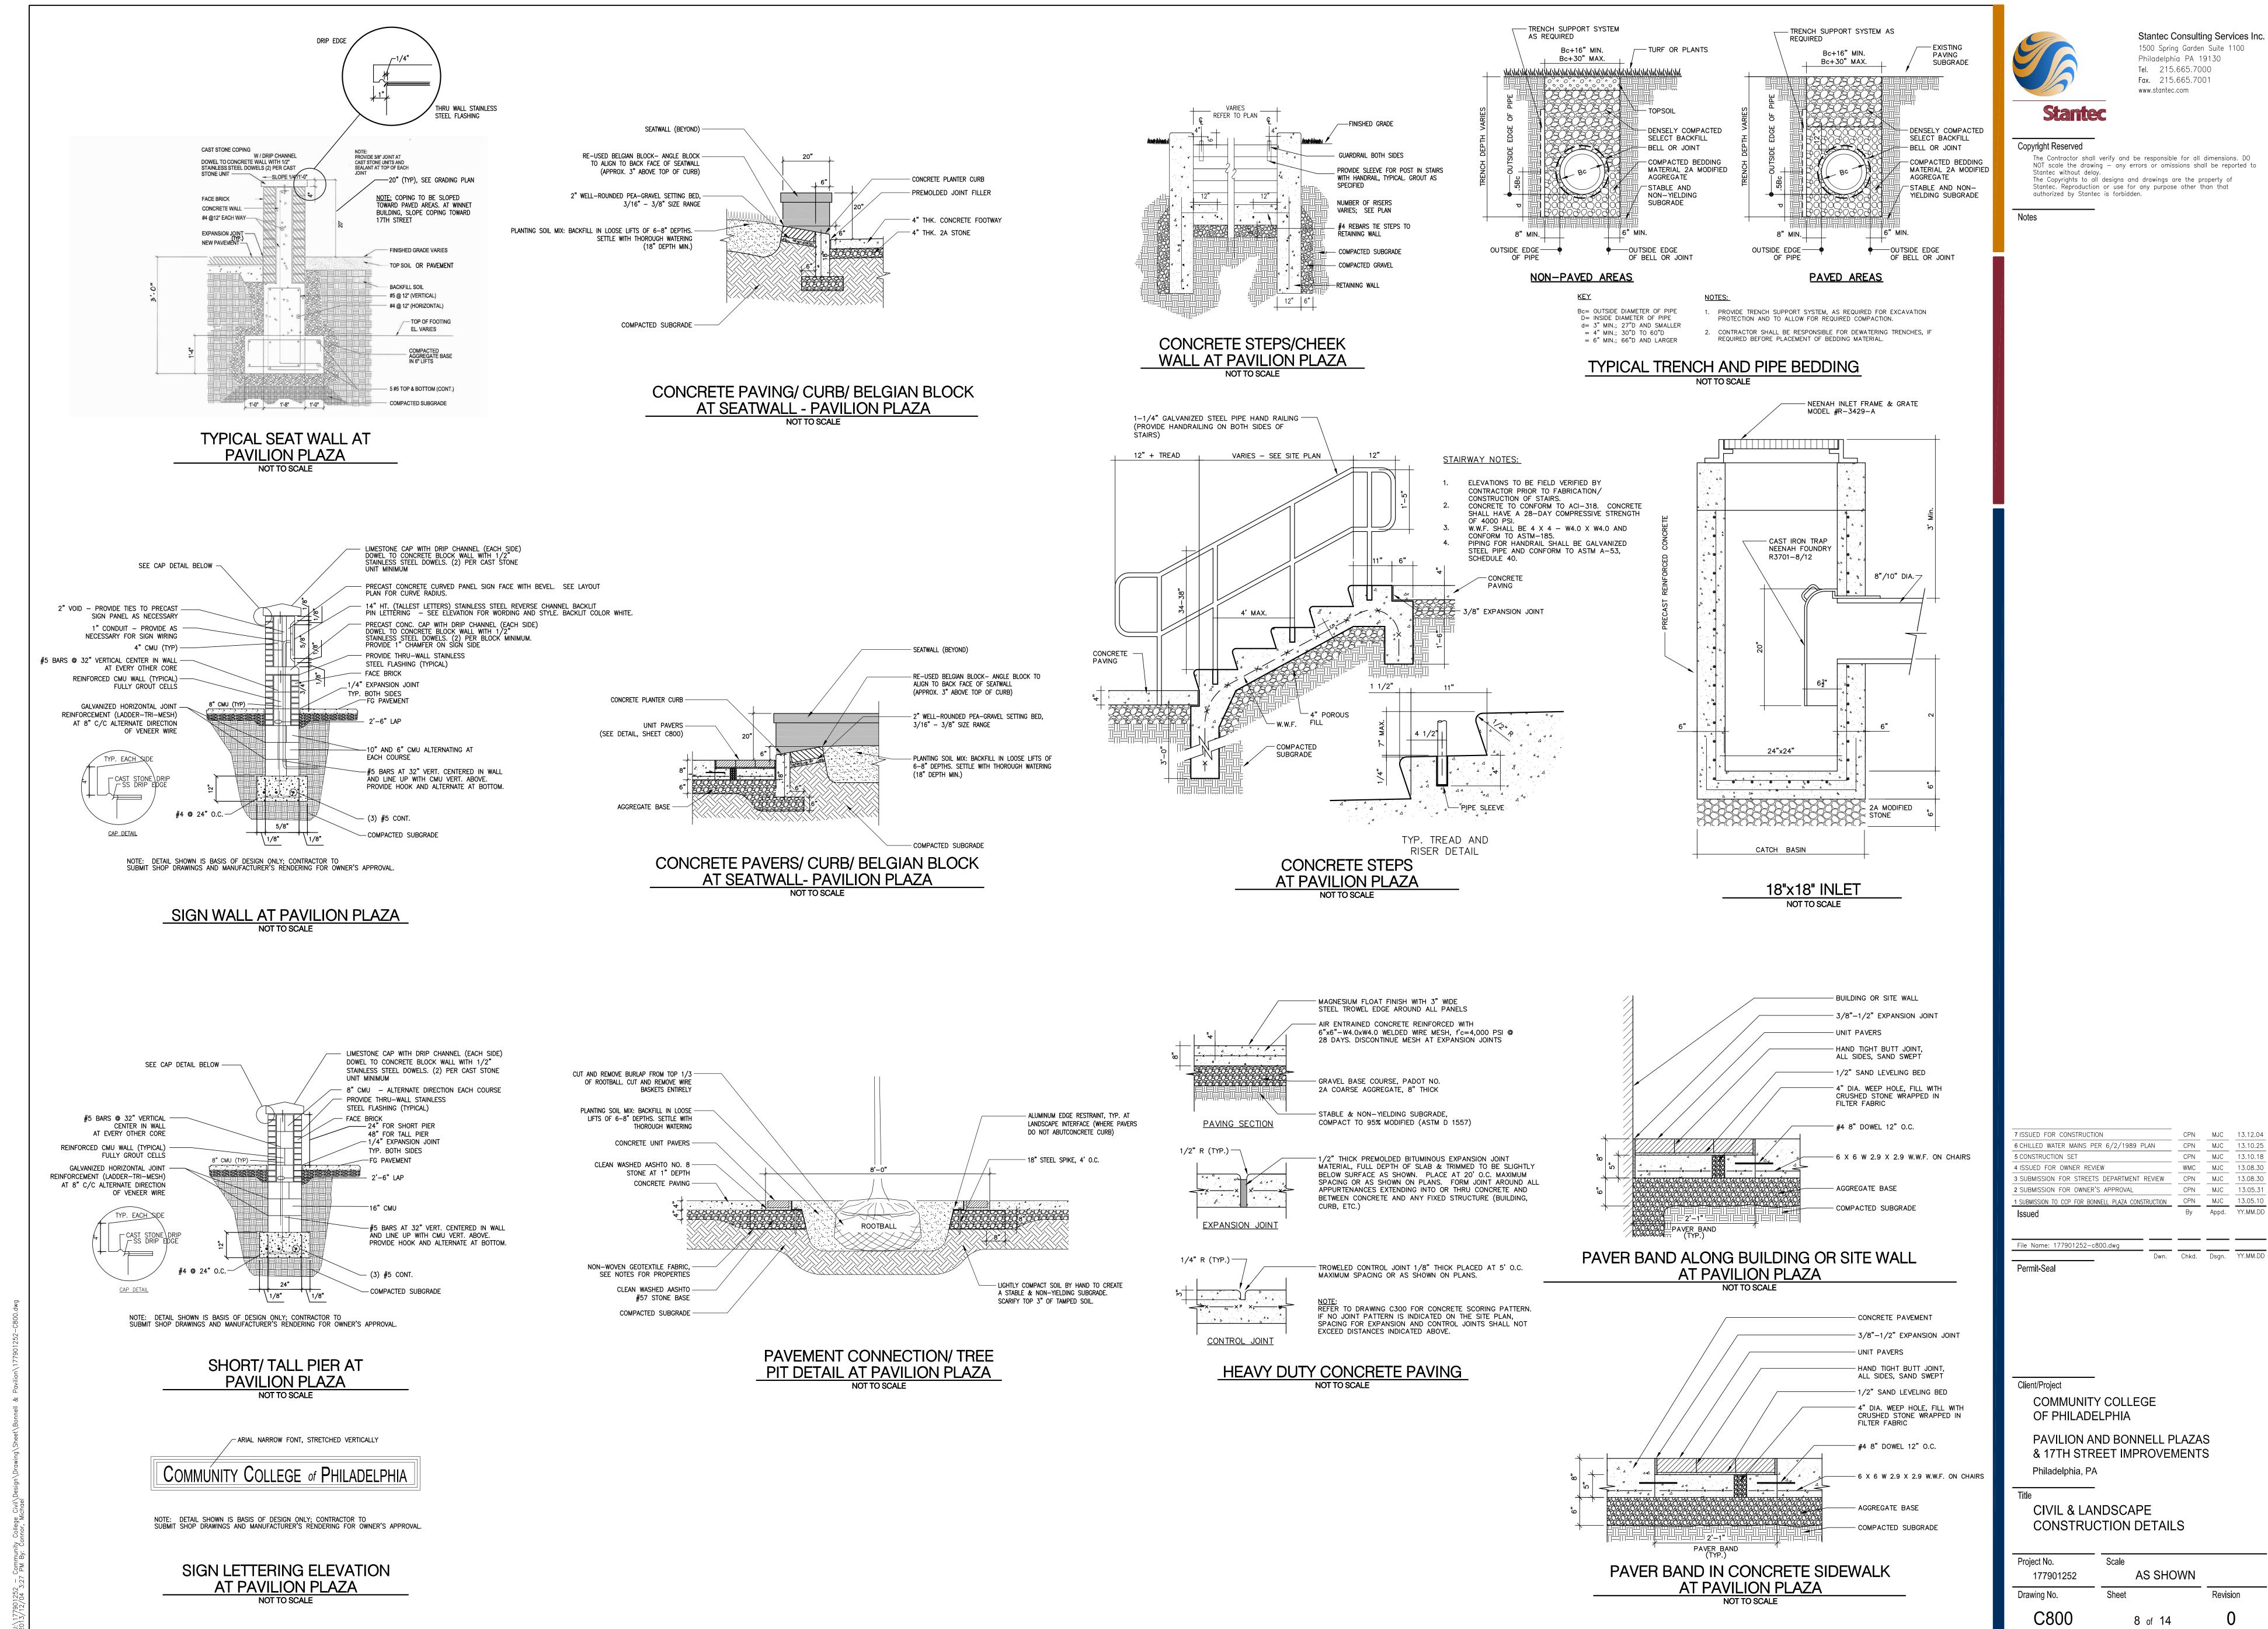


Stantec Consulting Services Inc. 1500 Spring Garden Suite 1100 Philadelphia PA 19130 Tel. 215.665.7000 Fax. 215.665.7001

The Contractor shall verify and be responsible for all dimensions. DO NOT scale the drawing — any errors or omissions shall be reported to The Copyrights to all designs and drawings are the property of Stantec. Reproduction or use for any purpose other than that


CPN MJC 13.12.04

PAVILION AND BONNELL PLAZAS


ORIGINAL SHEET - ARCH E1

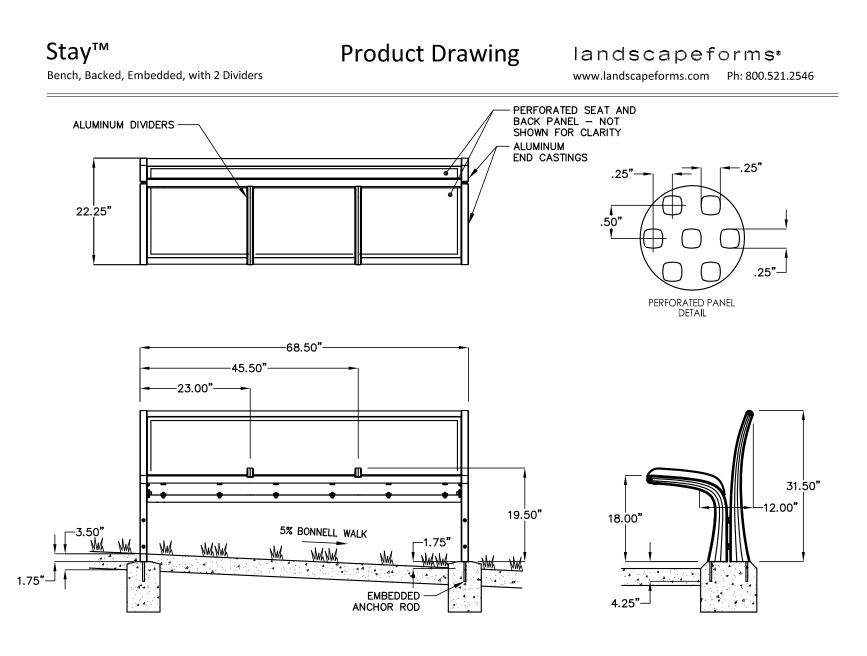

BENCH DETAIL **BONNELL WALK** NOT TO SCALE

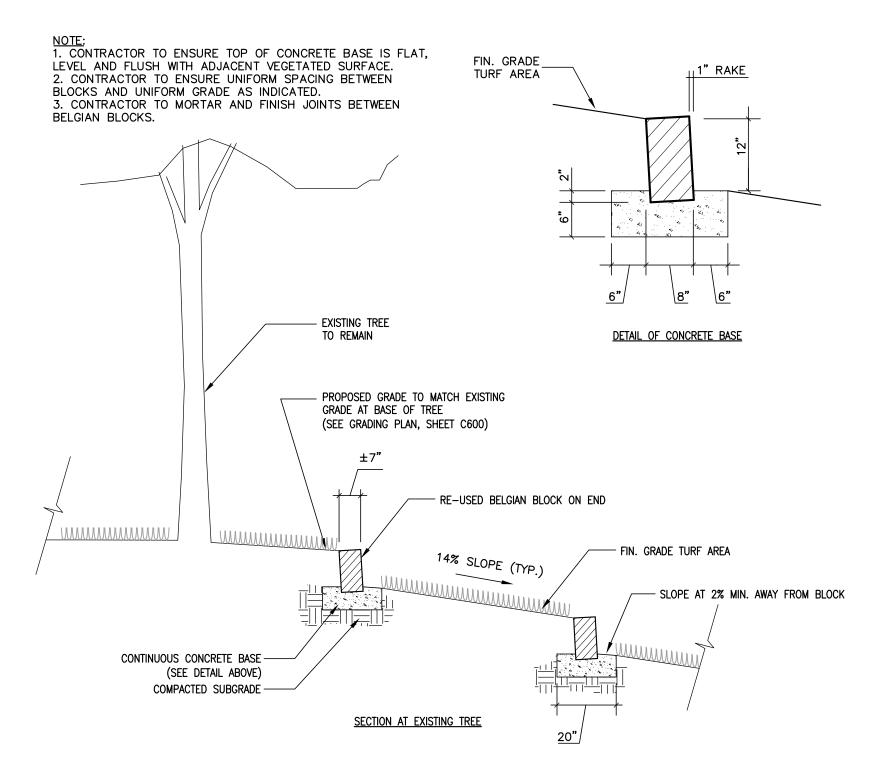

BELGIAN BLOCK KNEE WALL AT BONNELL PLAZA NOT TO SCALE

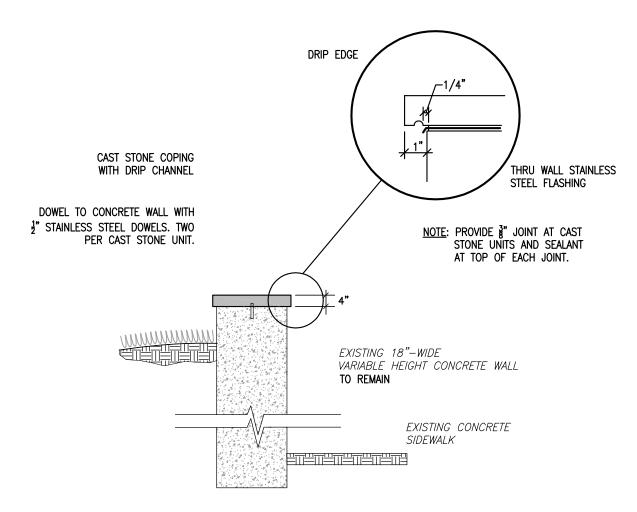

CAP DETAIL FOR EXISTING CONCRETE RETAINING WALL AT BONNELL PLAZA
NOT TO SCALE



Stantec Consulting Services Inc. 1500 Spring Garden Suite 1100 Philadelphia PA 19130 Tel. 215.665.7000 Fax. 215.665.7001 www.stantec.com

Copyright Reserved

The Contractor shall verify and be responsible for all dimensions. DO NOT scale the drawing — any errors or omissions shall be reported to Stantec without delay.

The Copyrights to all designs and drawings are the property of Stantec. Reproduction or use for any purpose other than that authorized by Stantec is forbidden.

Dwn.	Chkd.	Dsgn.	YY.MM.DD
File Name: 177901252—c801.dwg		<u> </u>	
Issued	Ву	Appd.	YY.MM.DD
1 SUBMISSION TO CCP FOR BONNELL PLAZA CONSTRUCTION		MJC	13.05.10
2 SUBMISSION FOR OWNER'S APPROVAL		MJC	13.05.31
SUBMISSION FOR STREETS DEPARTMENT REVIEW	CPN	MJC	13.08.30
4 ISSUED FOR OWNER REVIEW	WMC	MJC	13.08.30
5 CONSTRUCTION SET	CPN	MJC	13.10.18
6 CHILLED WATER MAINS PER 6/2/1989 PLAN	CPN	_MJC_	13.10.25
7 ISSUED FOR CONSTRUCTION	CPN	MJC	13.12.04

Client/Project


COMMUNITY COLLEGE OF PHILADELPHIA


PAVILION AND BONNELL PLAZAS & 17TH STREET IMPROVEMENTS Philadelphia, PA

CIVIL & LANDSCAPE CONSTRUCTION DETAILS

Project No. Scale AS SHOWN 177901252 Revision Drawing No.

ORIGINAL SHEET - ARCH E1

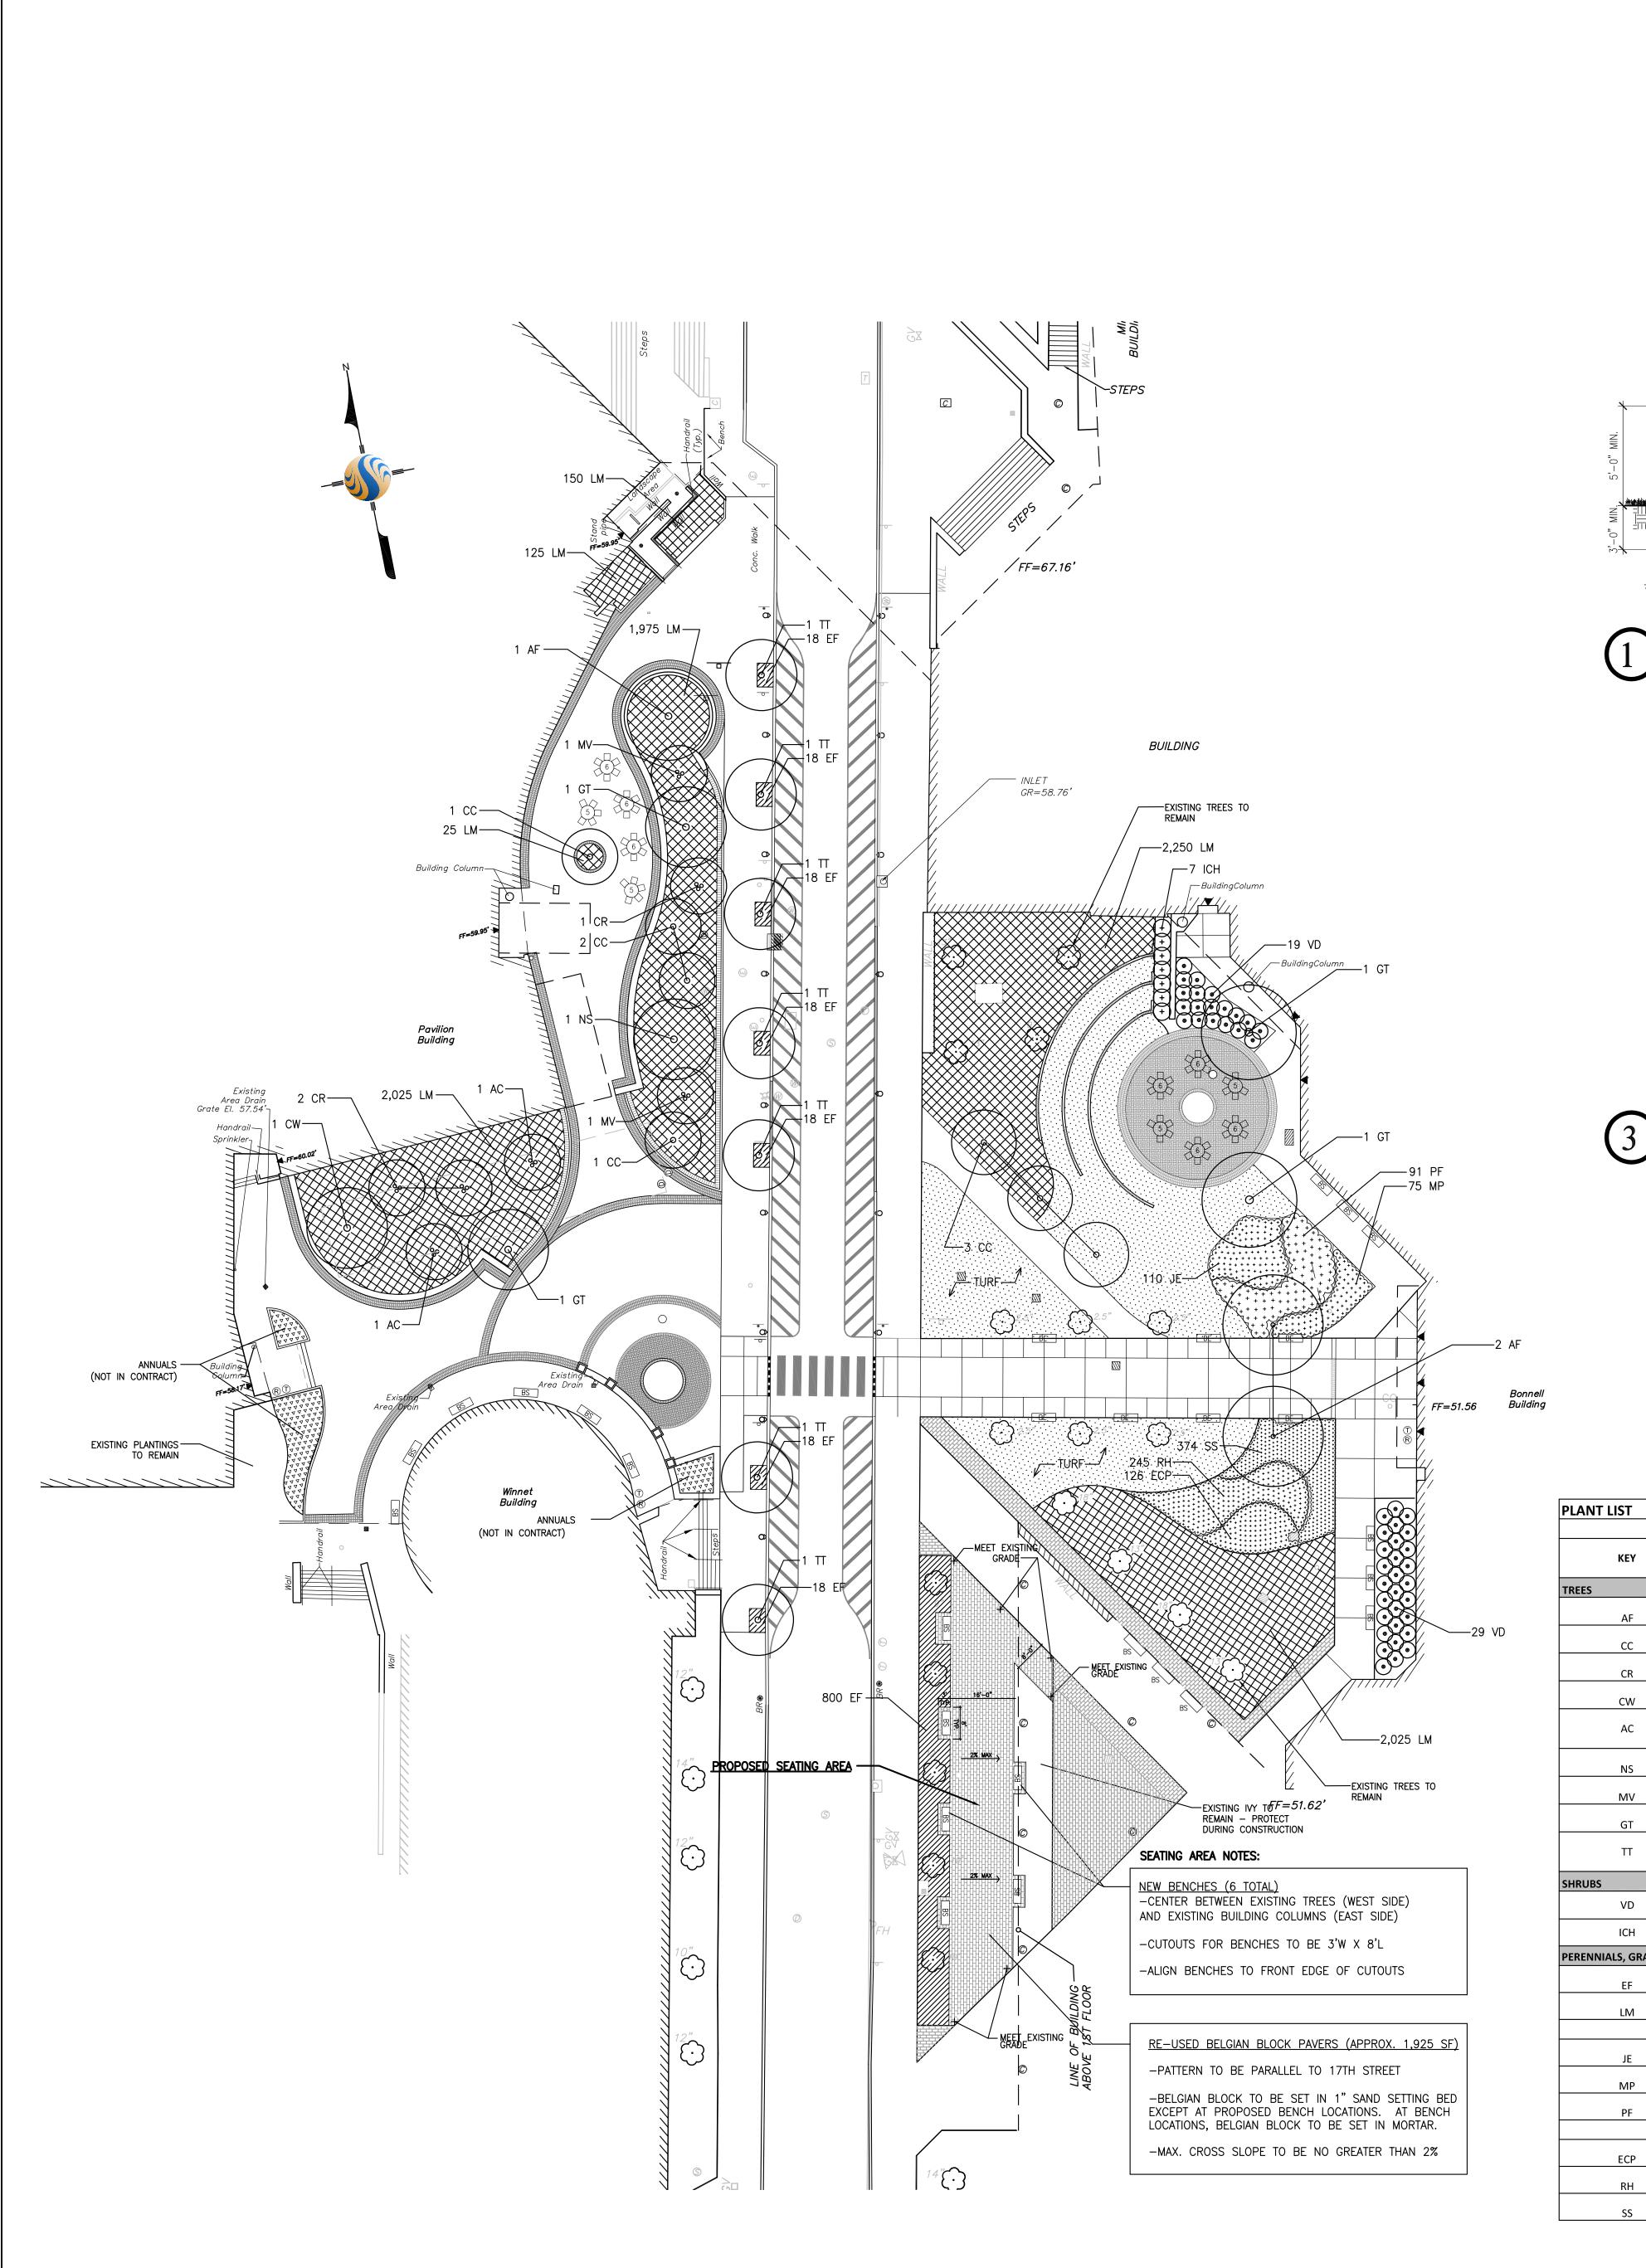

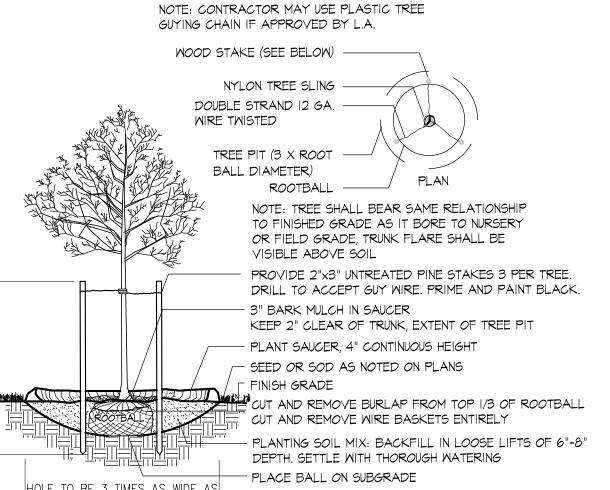



TYPICAL PLANTING - DECIDUOUS TREE

- 3" BARK MULCH IN SAUCER, NOT TO BE PILED AGAINST ROOT FLARE OR TRUNK PLANT SAUCER, 4" CONTINUOUS, NO SAUCER WHERE SHRUBS OCCUR IN BEDS FINISH GRADE THE CUT AND REMOVE ALL BURLAP FROM ROOT BALL PLANTING SOIL MIX: BACKFILL IN LOOSE LIFTS OF 6"-8" DEPTH. SETTLE WITH THOROUGH WATERING PLACE ROOT BALL ON UNDISTURBED SOIL. IF SOIL HAS BEEN DISTURBED, COMPACT TO MINIMIZE SETTLING.

I. SHRUB SHALL BEAR SAME RELATIONSHIP TO FINISHED GRADE AS IT BORE TO NURSERY OR FIELD GRADE

2. WHERE SHRUBS OCCUR IN GROUPINGS IN PLANT BEDS, PROVIDE 2 - FOOT DEEP CONTINUOUS LOAM BED.

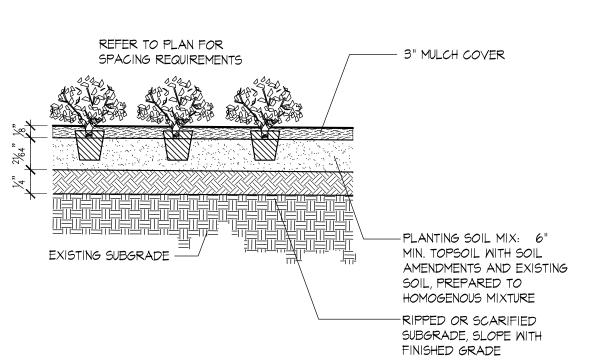

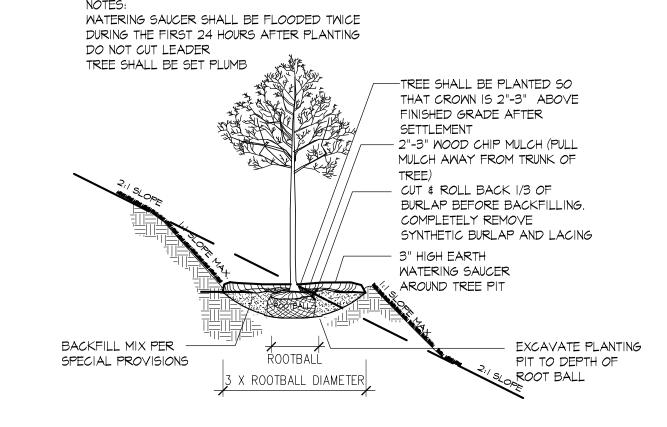

TYPICAL PLANTING - GROUNDCOVER

SCHIZACHYRIUM

LITTLE BLUESTEM

SCOPARIUM

THE ROOTBALL DIAMETER

TYPICAL PLANTING - ON SLOPES

DETAIL CONTAINER | SIZE SPACING NOTES **BOTANICAL NAME COMMON NAME** CELZAM CELEBRATION ACER x FREEMANII N/A 1/L100 'CELZAM' CARPINUS CAROLINIANA N/A 1/L100 AMERICAN HORNBEAM B&B 'PALISADE' N/A 1/L100 CERCIS CANADENSIS EASTERN REDBUD CRATAEGUS VIRIDIS WINTER KING 2 1/2" N/A 1/L100 'WINTER KING' HAWTHORNE AMELANCHIER **AUTUMN BRILLIANCE** 2 1/2" CANADENSIS 'AUTUMN B&B 1/L100 SERVICEBERRY BRILLIANCE' 6' BRANCH 1/L100 NYSSA SYLVATICA N/A BREAK N/A 1/L100 AAGNOLIA VIRGINIANA GLEDITSIA TRIACANTHOS | IMPERIAL THORNLESS 6' BRANCH N/A 1/L100 MATCHED, 6' TILIA TOMENTOSA 'GREEN | GREEN MOUNTAIN B&B N/A BRANCH 1/L100 MOUNTAIN' SILVER LINDEN CAL. BREAK VIBURNUM DENTATUM BLUE MUFFIN' #5 CONT. 24-30" 2/L100 ARROWOOD VIBURNUM #3 CONT. 24-30" 3 1/2' O.C. 2/L100 |ILEX CRENATA 'HELLERI' PERENNIALS, GRASSES, & GROUNDCOVER EUONYMUS FORTUNEI 3/L100 'COLORATUS' WINTERCREEPER 1 GAL. 12" O.C. LIRIOPE MUSCARI 'BIG IG BLUE LILYTURF 12" O.C. 3/L100 1 GAL. WETLAND PLANT GROUP SOFT RUSH CONTAINER 18" O.C. 3/L100 JUNCUS EFFUSUS MUHLENBERGIA PINK MUHLY GRASS CONTAINER 18" O.C. 3/L100 CAPILLARIS BUSH CINQUEFOIL CONTAINER 24" O.C. 3/L100 POTENTILLA FRUTICOSA **UPLAND PLANT GROUP** CONTAINER 15" O.C. 3/L100 ECP ECHINACEA PURPUREA PURPLE CONEFLOWER 15" O.C. 3/L100 CONTAINER UDBECKIA HIRTA BLACK-EYED SUSAN

PLUG

CALL BEFORE YOU DIG!

PENNSYLVANIA LAW REQUIRES THREE (3) WORKING DAYS NOTICE FOR CONSTRUCTION PHASE AND TEN (10) WORKING DAYS FOR DESIGN STAGE. UTILITY INFORMATION IDENTIFIED THROUGH THE ONE-CALL PROCESS IS VALID FOR 90 DAYS FROM THE DATE OF THE CALL. ONE CALL SERIAL NO. 2995492, 2995498, 2995507, 20121790546, 20121790547. Pennsylvania One Call System, Inc.

1-800-242-1776

UTILITY NOTE THE LOCATION OF UNDERGROUND UTILITIES AND FIELD LOCATION OF VENTS, VALVES, MANHOLES, INLETS ETC. PROVIDED BY HUNT ENGINEERING. THE EXTENT, EXACT LOCATION AND DEPTH OF UNDERGROUND UTILITIES HAS NOT BEEN INDEPENDENTLY VERIFIED BY STANTEC, THE OWNER, OR ITS REPRESENTATIVE. THE CONTRACTOR SHALL DETERMINE THE EXTENT AND EXACT LOCATION AND DEPTH OF ALL EXISTING UTILITIES PRIOR TO COMMENCING WORK. THE CONTRACTOR AGREES TO BE FULLY RESPONSIBLE FOR ANY AND ALL DAMAGES WHICH MIGHT BE OCCASIONED BY THE CONTRACTOR'S FAILURE TO EXACTLY LOCATE AND PRESERVE ANY AND ALL UNDERGROUND UTILITIES. CONTRACTOR SHALL NOTIFY UTILITY COMPANIES THREE (3) DAYS PRIOR TO COMMENCING WORK TO COMPLY WITH PENNA. ACT No.287. UTILITY COMPANIES HAVE ASSIGNED SERIAL #'S 2995492,

2995498, 2995507, TO THIS LOCATION BY HUNT ENGINEERING & SERIAL #'S 20121790546, 20121790547 BY STANTEC CONSULTING

3/L100


SERVICES INC.

12" O.C.

Stantec Consulting Services Inc. 1500 Spring Garden Suite 1100 Philadelphia PA 19130 Tel. 215.665.7000 Fax. 215.665.7001 www.stantec.com

Copyright Reserved

The Contractor shall verify and be responsible for all dimensions. DO NOT scale the drawing — any errors or omissions shall be reported to The Copyrights to all designs and drawings are the property of Stantec. Reproduction or use for any purpose other than that authorized by Stantec is forbidden.

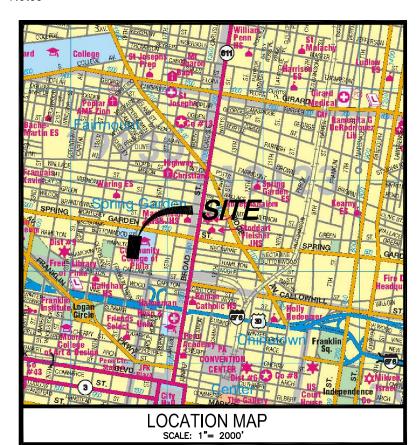

7 ISSUED FOR CONSTRUCTION CPN MJC 13.12.04 6 CHILLED WATER MAINS PER 6/2/1989 PLAN 4 ISSUED FOR OWNER REVIEW 3 SUBMISSION FOR STREETS DEPARTMENT REVIEW CPN MJC 13.08.30 CPN MJC 13.05.31 2 SUBMISSION FOR OWNER'S APPROVAL

Permit-Seal


Client/Project

COMMUNITY COLLEGE OF PHILADELPHIA

PAVILION AND BONNELL PLAZAS & 17TH STREET IMPROVEMENTS Philadelphia, PA

Title LANDSCAPE PLAN

Project No. 177901252	Scale 1"=20'	
Drawing No.	Sheet	Revision
L-100	10 of 14	0

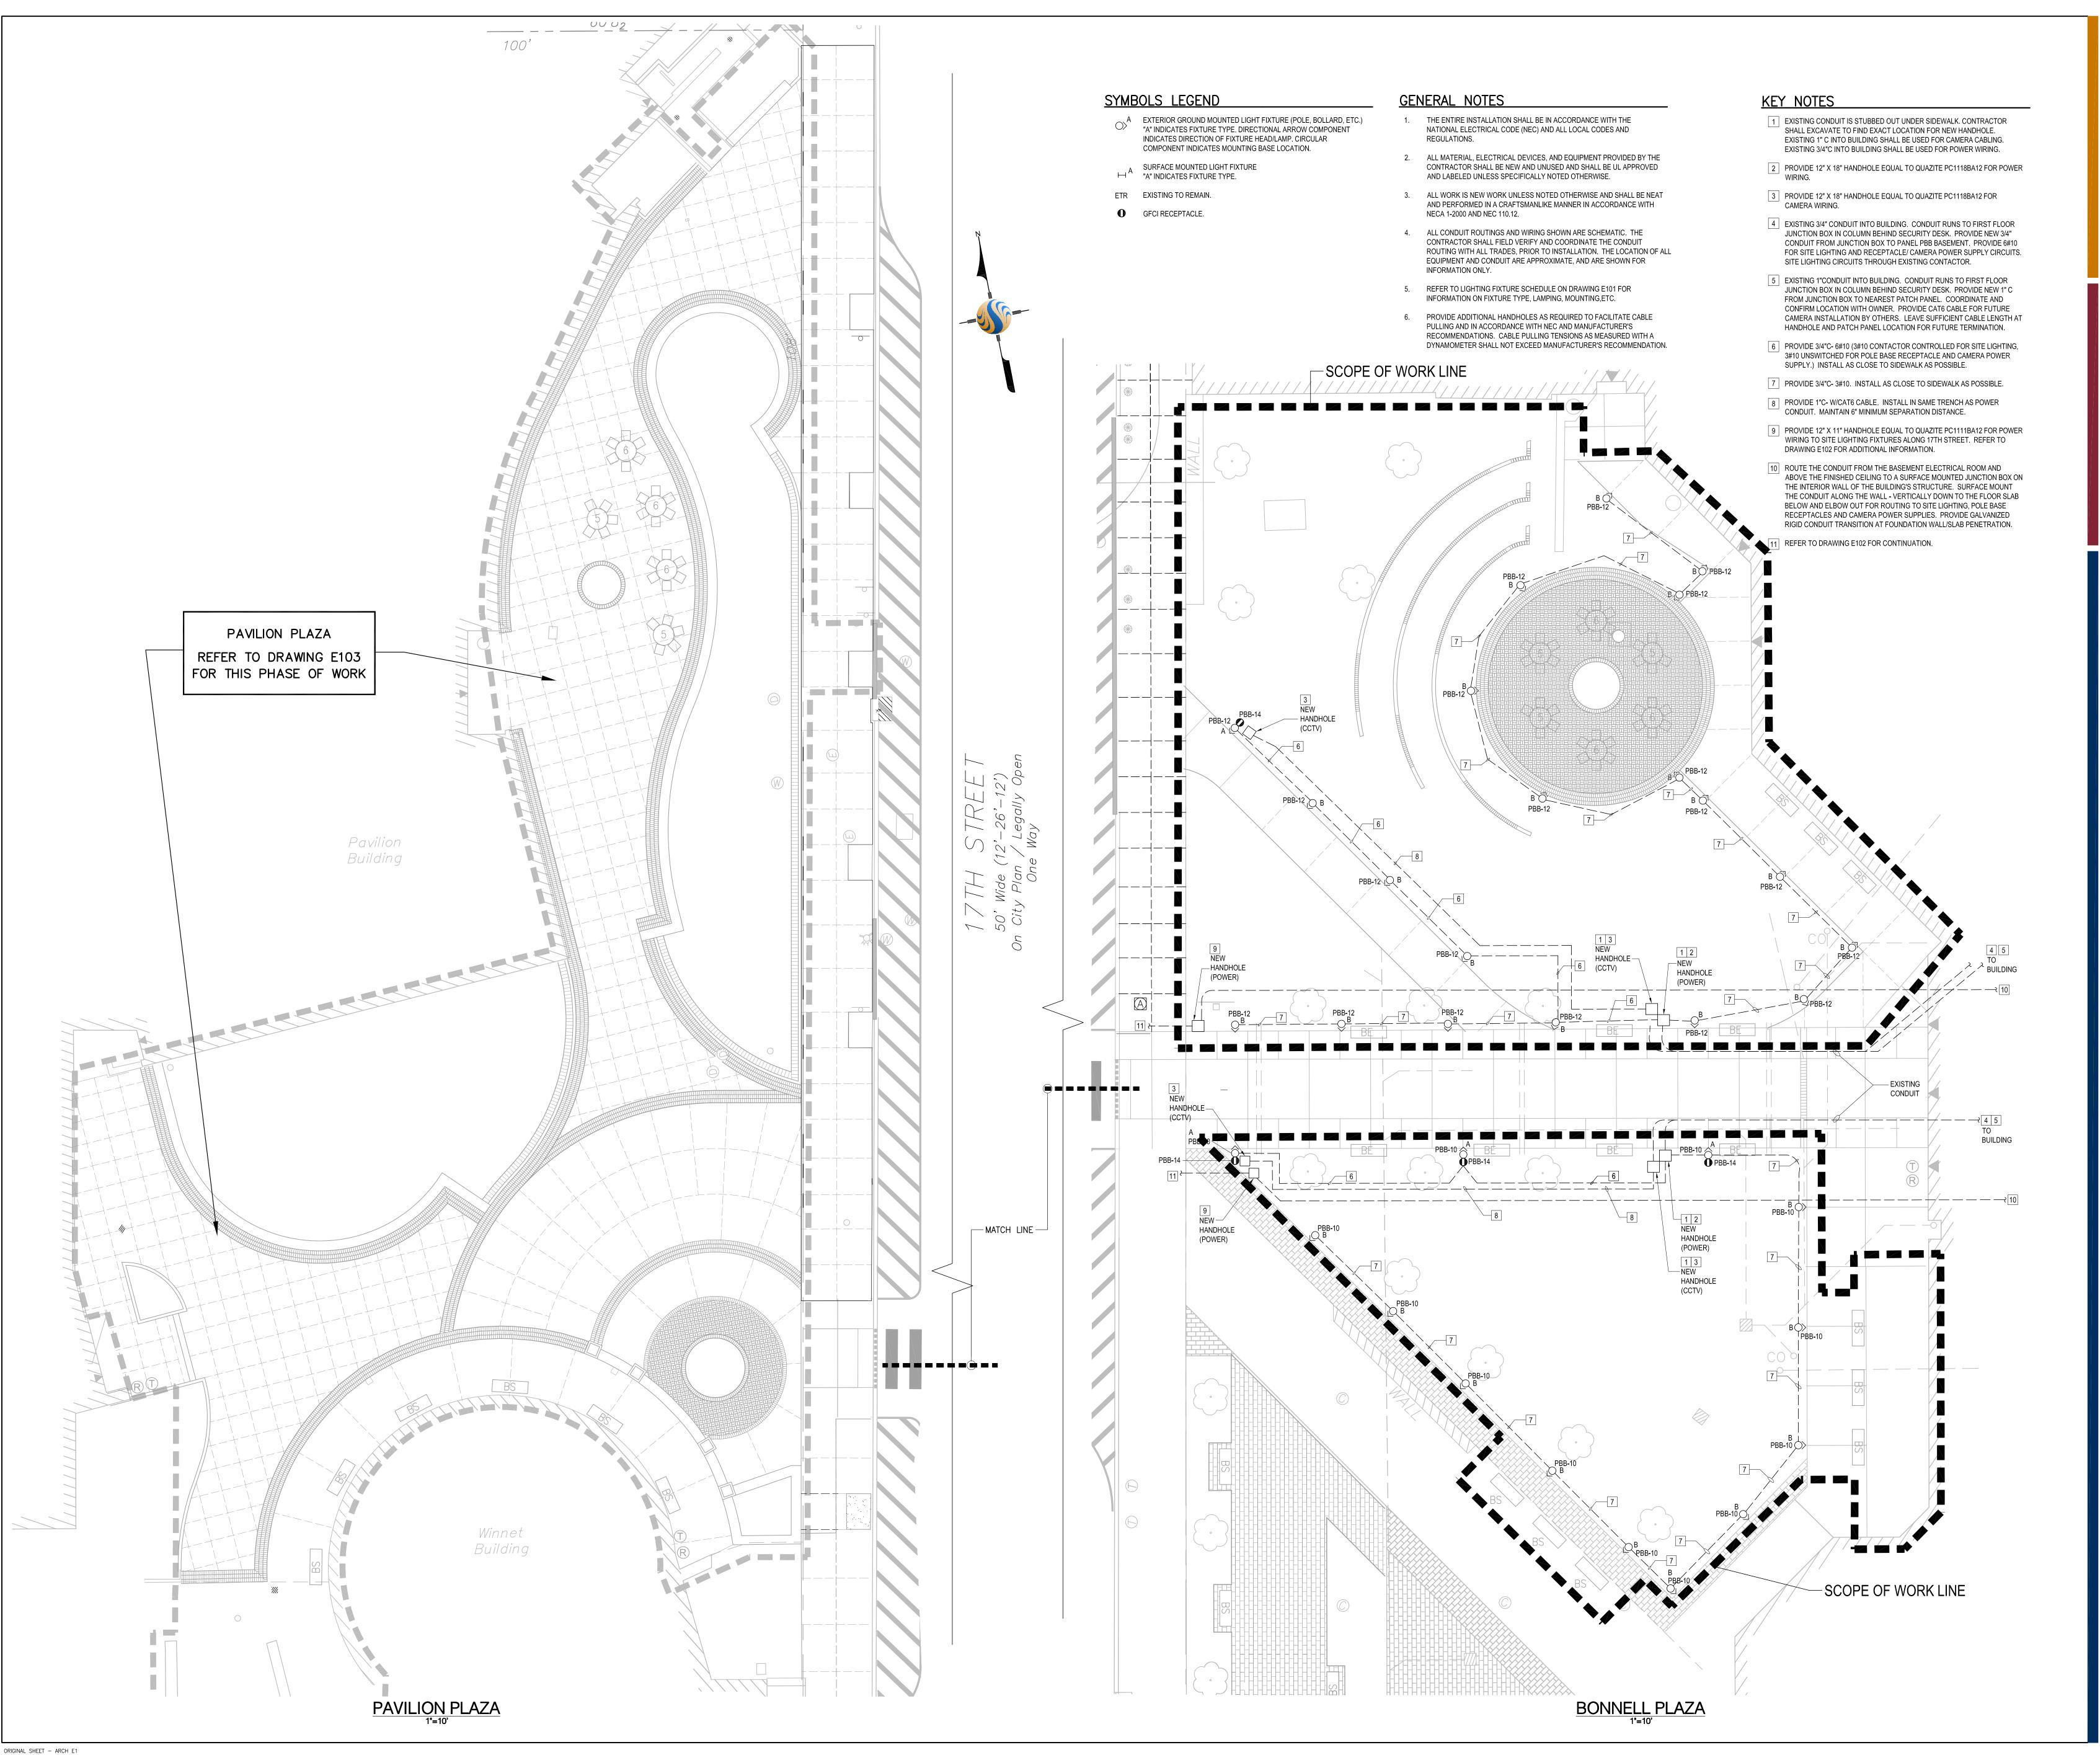



Stantec Consulting Services Inc. 1500 Spring Garden Suite 1100

Philadelphia PA 19130 Tel. 215.665.7000 Fax. 215.665.7001 www.stantec.com

Copyright Reserved

The Contractor shall verify and be responsible for all dimensions. DO NOT scale the drawing — any errors or omissions shall be reported to Stantec without delay. The Copyrights to all designs and drawings are the property of Stantec. Reproduction or use for any purpose other than that authorized by Stantec is forbidden.



- GENERAL NOTES:

 1. ALL EXISTING CONDITION INFORMATION DEPICTED ON THE PLAN IS PER HUNT ENGINEERING PLANS TITLED "CIVIL EXISTING CONDITIONS 1" AND "CIVIL EXISTING CONDITIONS 2" DATED JUNE 12, 2009. THE PLAN HAS BEEN AMENDED BY STANTEC CONSULTING SERVICES INC. THROUGH THE INCLUSION OF THE EXISTING UNDERGROUND ELECTRIC VAULT AND OIL TANK WHICH ARE SITUATED WITHIN THE BONNELL PLAZA ANEX. THE INFORMATION IS REFERENCED FROM PLAN TITLED 'GROUND FLOOR PLAN SOUTH 'C'" BY THE KLING PARTNERSHIP DATED NOVEMBER 30, 1979 AND "DETAILS & DIAGRAMS SOUTH MINT WEST" BY THE KLING PARTNERSHIP DATED NOVEMBER 30, 1979 AND LAST REVISED SEPTEMBER 1, 1982.

 BENCHMARK IS CALLED OUT ON THE HUNT ENGINEERING PLANS NOTED ABOVE AT THE FOLLOWING LOCATION: 17TH STREET AND SPRING GARDEN ADDRESS OF THE PROCESS OF
- STREET, SOUTHWEST CORNER OF INTERSECTION, EAST END OF LOWEST GRANITE STEP AT THE MAIN ENTRANCE TO LIBRARY, ELEVATION 68.28. ATTENTION IS CALLED TO THE PHILADELPHIA ZONING CODE AS AMENDED. PROPERTY IS ZONED IDD.

 SUBJECT PREMISES DOES NOT LIE WITHIN A FLOOD HAZARD AREA.
- SUBJECT PREMISES IS AN AREA "X" AS PER FEDERAL EMERGENCY MANAGEMENT AGENCY FLOOD INSURANCE MAP COMMUNITY PANEL 420757—0183G, LAST REVISED JANUARY 17, 2007.

 UTILITIES ENTER THE PREMISES FROM PUBLIC STREETS OR RIGHT OF WAY.

 NO ADDITIONAL FIELD SURVEY OR EXISTING UTILITY RESEARCH FOR PUBLIC
- UTILITIES HAS BEEN PERFORMED BY STANTEC CONSULTING SERVICES INC. SHOULD ANY DISCREPANCIES BE FOUND WITH EXISTING FEATURES DURING CONSTRUCTION, THE CONTRACTOR SHALL REMEDY THE DISCREPANCY WITH THE OWNER OR THE OWNER'S SURVEYOR (HUNT ENGINEERING).

 ALL PROPOSED UTILITY SERVICES WILL BE UNDERGROUND OR WILL ENTER PROPOSED PROPERTY FROM THE PUBLIC RIGHT—OF—WAY.

 THE CONTRACTOR SHALL CONFORM TO ALL THE REQUIREMENTS OF PA ACT
- 9. REFER TO PLAN TITLED "CIVIL EROSION AND SEDIMENT CONTROL PLAN" AND "CIVIL DETAILS 2" DATED SEPTEMBER 23, 2009 BY HUNT ENGINEERING FOR THE APPROVED EROSION AND SEDIMENT CONTROL PLAN FOR NPDES

NOTE:
UNDERGROUND UTILITY INFORMATION DEPICTED ON PLANS IS
TAKEN FROM SURVEY AND DESIGN PLANS PROVIDED BY HUNT ENGINEERING. NO ADDITIONAL FIELD SURVEY OR EXISTING UTILITY RESEARCH FOR PUBLIC UTILITIES HAS BEEN PERFORMED BY STANTEC CONSULTING SERVICES INC. SHOULD ANY DISCREPANCIES BE FOUND WITH EXISTING FEATURES DURING CONSTRUCTION, THE CONTRACTOR SHALL REMEDY THE

DISCREPANCY WITH THE OWNER OR THE OWNER'S SURVEYOR

7 ISSUED FOR CONSTRUCTION	CPN	MJC	13.12.04
6 CHILLED WATER MAINS PER 6/2/1989 PLAN	CPN	MJC	13.10.25
5 CONSTRUCTION SET	CPN	MJC	13.10.18
4 ISSUED FOR OWNER REVIEW	WMC	MJC	13.08.30
3 SUBMISSION FOR STREETS DEPARTMENT REVIEW	CPN	MJC	13.08.30
2 SUBMISSION FOR OWNER'S APPROVAL	CPN	MJC	13.05.31
1 SUBMISSION TO CCP FOR BONNELL PLAZA CONSTRUCTION	CPN	MJC	13.05.10
Issued	Ву	Appd.	YY.MM.DD

File Name: 177901252-e100.dwg Dwn. Chkd. Dsgn. YY.MM.DD Permit-Seal

Client/Project


(HUNT ENGINEERING).

COMMUNITY COLLEGE OF PHILADELPHIA


PAVILION AND BONNELL PLAZAS **& 17TH STREET IMPROVEMENTS** Philadelphia, PA

ELECTRICAL & SITE LIGHTING PLAN **BONNELL PLAZA**

Project No. 177901252	Scale 1"=10'	
Drawing No.	Sheet	Revision
E100	11 of 14	0

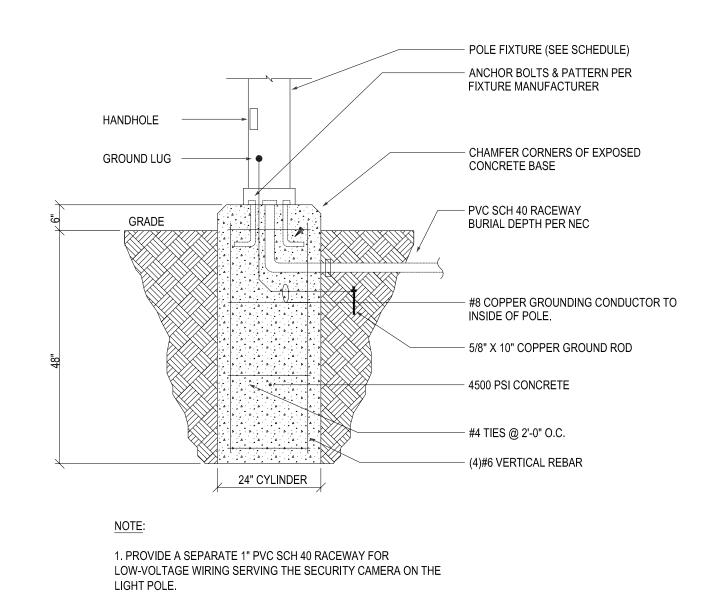

1 TYPICAL 6" BASE FOR LIGHT POLE MOUNTING (POLES ABOVE 4'-0" HIGH)
NOT TO SCALE

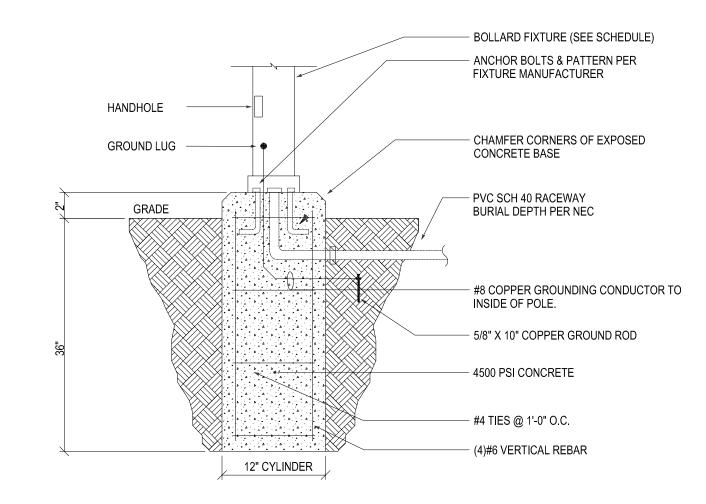

2" BOLLARD BASE MOUNTING DETAIL (FIXTURES LESS THEN 4'-0" HIGH)
NOT TO SCALE

LIGHTING FIXTURE SCHEDULE								
FIXTURE TAG	DESCRIPTION	MOUNTING	LAMP QUANTITY/ TYPE	WATTS	VOLTAGE	MANUFACTURER	CATALOG NUMBER OR SERIES	NOTES
A	PEDESTRIAN SCALE LED POLE LIGHT, PENDANT STYLE, WITH CLEAR SHALLOW DROP GLASS LENS, TYPE II, GRAY FINISH, BANNER ARM, GFI RECEPTACLE, 4" ALUMINUM POLE WITH 6" BASE, CLEAR SKY FRIENDLY, 24" ARM	POLE	3500K LED	75	120	KING LUMINAIRE	K803-FASH-II-75-SSL-8000-120-GY	1,2
A2	PEDESTRIAN SCALE LED POLE LIGHT, PENDANT STYLE, WITH CLEAR SHALLOW DROP GLASS LENS, TYPE II, GRAY FINISH, BANNER ARM, GFI RECEPTACLE, 4" ALUMINUM POLE WITH 6" BASE, CLEAR SKY FRIENDLY, 36" ARM	POLE	3500K LED	75	120	KING LUMINAIRE	K803-FASH-II-75-SSL-8000-120-GY	2,6
В	42" HIGH LED BOLLARD WITH FULL LIGHT CUTOFF, ASYMMETRIC TYPE III DISTRIBUTION, SILVER FINISH	BOLLARD	3500K LED	12	120	SELUX	NT-3.5-LG3700-35-SV-120	5
С	9" LED BOLLARD WITH ROTATIONALLY SYMMETRICAL DISTRIBUTION, SILVER FINISH, ANCHORAGE KIT, INTEGRAL DRIVER, CLEAR SKY FRIENDLY	LOW-LEVEL BOLLARD	3000K LED	24.5	120	BEGA	7740LED-K3-SLV-895A	-
D	4" SQUARE LED STEP LIGHT WITH WHITE GLASS LENS, IP67, STAINLESS STEEL TRIM, INTEGRAL DRIVER	WALL MOUNTED STEP LIGHT	3000K LED	5	120	COLE LIGHTING	L121 SERIES	-
E	SMALL PROFILE LED STRIP LIGHT, IP66 RATED, 13" LENGTHS FOR FIELD CURVABLE APPLICABLE, HINGED ADJUSTABLE BRACKETS, REMOTE DRIVERS	SURFACE	3500K LED	8W/FT	24/120	I2 SYSTEMS	V3285-A-1-3-CBC-OUTDOOR-BLACK ANODIZE-VLA5	4


1. PROVIDE FIXTURE WITH 14' POLE EQUAL TO STRESSCRETE "PORT CREDIT STYLE" CATALOG #KSB82-A-14-BE-BA-GFI AND SINGLE ARM EQUAL TO KA94-S-A-BK. ARM SHALL EXTEND 24" FROM POLE BASE WITH 6"

2. REFER TO DETAIL 1 ON DRAWING E101 FOR MOUNTING INFORMATION UNLESS OTHERWISE NOTED.

4. PROVIDE OUTDOOR RATED DRIVERS FOR MOUNTING IN ADJACENT HANDHOLES. PROVIDE QUANTITY OF DRIVES SUITABLE FOR OPERATING QUANTITY OF FIXTURES AS INDICATED ON PLAN. DRIVER SHALL BE EQUAL TO E05PW. PROVIDE ALL MOUNTING ACCESSORIES FOR MOUNTING ALONG WALL. REFER TO ARCHITECTURAL SECTIONS FOR DETAILS ON MOUNTING.

6. PROVIDE FIXTURE WITH 14' POLE EQUAL TO STRESSCRETE "PORT CREDIT STYLE" CATALOG #KSB82-A-14-BE-BA AND SINGLE ARM EQUAL TO KA94-S-A-BK. ARM SHALL EXTEND 36" FROM POLE BASE WITH 6" RISE.

1. IF DISCREPANCY EXISTS BETWEEN FIXTURE CATALOG NUMBER AND FIXTURE DESCRIPTION, FIXTURE DESCRIPTION SHALL TAKE PRECEDENCE.
2. TARGET ILLUMINANCE LEVELS ON THE PAVEMENT ARE 2.0 FOOTCANDLES MINIMUM MAINTAINED.

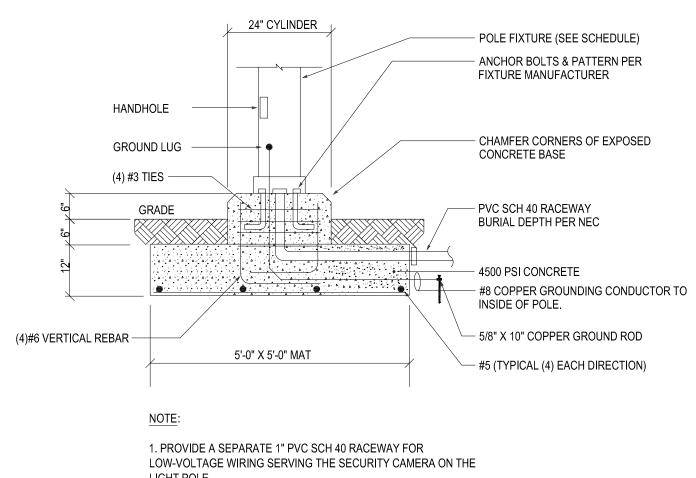

SPECIALTY 6" BASE FOR LIGHT POLE MOUNTING WITH UTILITIES BELOW NOT TO SCALE



Stantec Consulting Services Inc.
1500 Spring Garden Suite 1100
Philadelphia PA 19130
Tel. 215.665.7000
Fax. 215.665.7001
www.stantec.com

Stante

Copyright Reserved

The Contractor shall verify and be responsible for all dimensions. DO NOT scale the drawing — any errors or omissions shall be reported to Stantec without delay.

The Copyrights to all designs and drawings are the property of Stantec. Reproduction or use for any purpose other than that authorized by Stantec is forbidden.

Notes

THE				
MOUNTING WITH UTILITIES BELOW				
				13.12.04
				13.10.18
$\overline{4 \text{ IS}}$	SSUED FOR OWNER REVIEW	WMC I	MJC	13.08.30

Client/Project

COMMUNITY COLLEGE

2 SUBMISSION FOR OWNER'S APPROVAL

File Name: 177901252-e101.dwg

Permit-Seal

OF PHILADELPHIA

PAVILION AND BONNELL PLAZAS

PAVILION AND BONNELL PLAZAS & 17TH STREET IMPROVEMENTS Philadelphia, PA

3 SUBMISSION FOR STREETS DEPARTMENT REVIEW CPN MJC 13.08.30

LIGHTING & ELECTRICAL DETAILS


 Project No.
 Scale

 177901252
 NOT TO SCALE

 Drawing No.
 Sheet
 Revision

 E101
 12 of 14
 0

ORIGINAL SHEET - ARCH E1

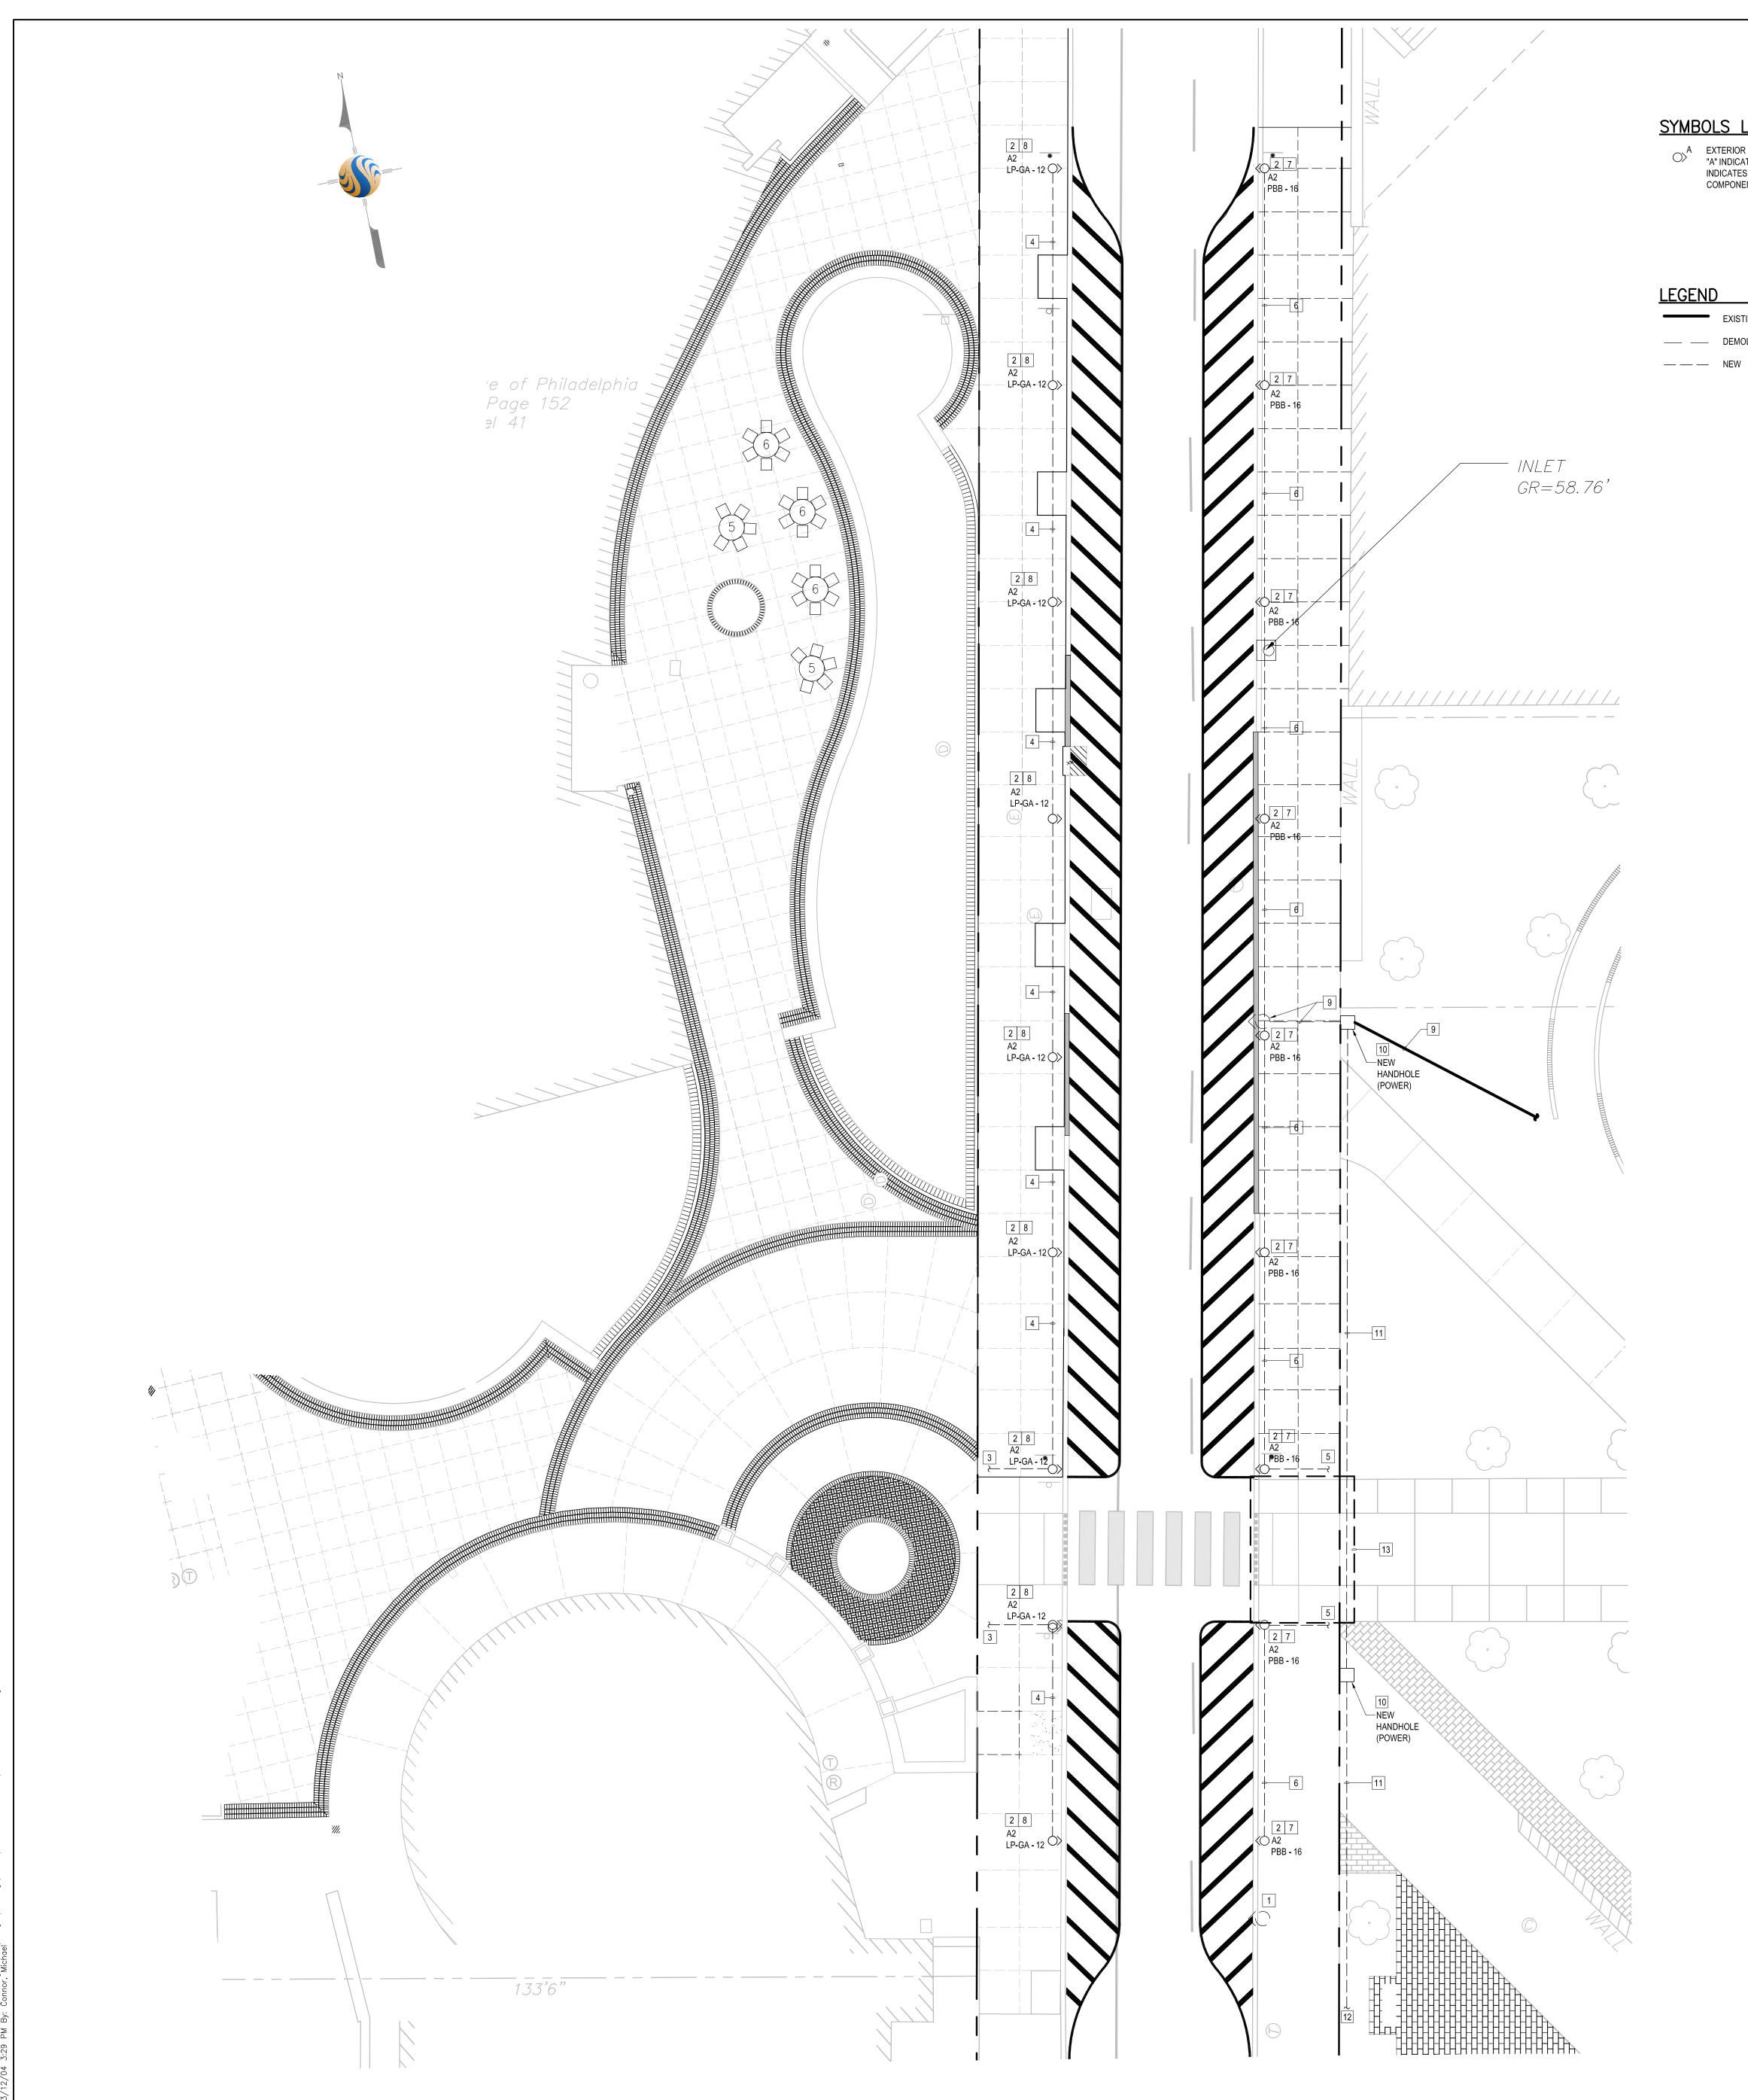

ORIGINAL SHEET - ARCH E1

EXTERIOR GROUND MOUNTED LIGHT FIXTURE (POLE, BOLLARD, ETC.)
"A" INDICATES FIXTURE TYPE. DIRECTIONAL ARROW COMPONENT INDICATES DIRECTION OF FIXTURE HEAD/LAMP. CIRCULAR COMPONENT INDICATES MOUNTING BASE LOCATION.

EXISTING — DEMOLITION

SYMBOLS LEGEND

1. THE ENTIRE INSTALLATION SHALL BE IN ACCORDANCE WITH THE

GENERAL NOTES

- NATIONAL ELECTRICAL CODE (NEC) AND ALL LOCAL CODES AND REGULATIONS.
- ALL MATERIAL, ELECTRICAL DEVICES, AND EQUIPMENT PROVIDED BY THE CONTRACTOR SHALL BE NEW AND UNUSED AND SHALL BE UL APPROVED AND LABELED UNLESS SPECIFICALLY NOTED OTHERWISE.
- 3. ALL WORK IS NEW WORK UNLESS NOTED OTHERWISE AND SHALL BE NEAT AND PERFORMED IN A CRAFTSMANLIKE MANNER IN ACCORDANCE WITH NECA 1-2000 AND NEC 110.12.
- 4. ALL CONDUIT ROUTINGS AND WIRING SHOWN ARE SCHEMATIC. THE CONTRACTOR SHALL FIELD VERIFY AND COORDINATE THE CONDUIT ROUTING WITH ALL TRADES, PRIOR TO INSTALLATION. THE LOCATION OF ALL EQUIPMENT AND CONDUIT ARE APPROXIMATE, AND ARE SHOWN FOR INFORMATION ONLY.
- REFER TO LIGHTING FIXTURE SCHEDULE ON DRAWING E101 FOR INFORMATION ON FIXTURE TYPE, LAMPING, MOUNTING, ETC.
- 6. PROVIDE ADDITIONAL HANDHOLES AS REQUIRED TO FACILITATE CABLE PULLING AND IN ACCORDANCE WITH NEC AND MANUFACTURER'S RECOMMENDATIONS. CABLE PULLING TENSIONS AS MEASURED WITH A DYNAMOMETER SHALL NOT EXCEED MANUFACTURER'S RECOMMENDATION.

KEY NOTES

- 1 REMOVE EXISTING LIGHT FIXTURE AND WOODEN UTILITY POLE. REMOVE EXISTING OVERHEAD WIRING BACK TO ITS NEXT ACTIVE DEVICE.
- 2 REFER TO LIGHTING FIXTURE SCHEDULE ON DRAWING E101 FOR POLE BASE MOUNTING DETAIL. WHERE UNDERGROUND UTILITIES DO NOT PERMIT THE POLE FOUNDATION DEPTH INDICATED FOR THE FIXTURE, PROVIDE ALTERNATE POLE BASE MOUNTING DETAIL (DETAIL 4/E101). CONSULT CIVIL ENGINEER, AND COLLEGE REPRESENTATIVE PRIOR TO CHANGES REGARDING POLE BASE.
- 3 PROVIDE 3/4"C 3#10 CONTACTOR CONTROLLED FOR SITE LIGHTING. REFER TO DRAWING E103 FOR CONTINUATION OF THE CONDUIT/WIRING
- 4 PROVIDE 3/4"C 3#10 CONTACTOR CONTROLLED FOR SITE LIGHTING.
- 5 PROVIDE 3/4"C 3#10 CONTACTOR CONTROLLED FOR SITE LIGHTING. REFER TO DRAWING E100 FOR CONTINUATION OF THE CONDUIT/WIRING
- 6 PROVIDE 3/4"C 3#10 CONTACTOR CONTROLLED FOR SITE LIGHTING.
- 7 CONNECT TO PANEL THROUGH NEW LIGHTING CONTACTOR (3 POLE, ELECTRICAL HELD, NEMA 1 ENCLOSURE; BMS CONTROLLED). LOCATE THE NEW LIGHTING CONTACTOR IN THE BASEMENT ELECTRICAL ROOM WHERE PANEL PBB IS LOCATED. COORDINATE EXACT LOCATION IN THE FIELD WITH THE OWNER.
- 8 CONNECT TO PANEL THROUGH EXISTING LIGHTING CONTACTOR, C2, LOCATED IN THE GROUND LEVEL ELECTRICAL ROOM OF PAVILION BUILDING.
- 9 REMOVE EXISTING LIGHT FIXTURE AND WOODEN UTILITY POLE. REMOVE AND RETAIN THE EXISTING WIRING FOR REUSE TO REFEED THE REMAINING SITE LIGHTING FIXTURES LOCATED ALONG 17TH STREET, OUTSIDE THE SCOPE OF WORK.
- 10 PROVIDE 12" X 11" HANDHOLE EQUAL TO QUAZITE PC1111BA12 TO REFEED POWER WIRING TO EXISTING SITE LIGHTING FIXTURES ALONG 17TH
- 11 PROVIDE 1"C 3#8 FOR EXISTING SITE LIGHTING FIXTURES ALONG 17TH
- 12 CIRCUIT DOWN TO EXISTING OVERHEAD POLE TO REMAIN. PROVIDE CONDUIT UP POLE AND RECONNECT TO EXISTING OVERHEAD WIRING THAT SERVES EXISTING SITE LIGHTING FIXTURES THAT ARE NOT IN THE SCOPE
- 13 DIRECTIONAL BORING SHALL BE USED IN THIS AREA TO PREVENT ANY DISTURBANCE TO THE EXISTING CONDITION.



Stantec Consulting Services Inc. 1500 Spring Garden Suite 1100 Philadelphia PA 19130 Tel. 215.665.7000

Fax. 215.665.7001 www.stantec.com

Copyright Reserved

The Contractor shall verify and be responsible for all dimensions. DO NOT scale the drawing — any errors or omissions shall be reported to The Copyrights to all designs and drawings are the property of Stantec. Reproduction or use for any purpose other than that authorized by Stantec is forbidden.



GENERAL NOTES:

1. ALL EXISTING CONDITION INFORMATION DEPICTED ON THE PLAN IS PER HUNT ENGINEERING PLANS TITLED "CIVIL EXISTING CONDITIONS — 1" AND "CIVIL EXISTING CONDITIONS — 2" DATED JUNE 12, 2009. THE PLAN HAS BEEN AMENDED BY STANTEC CONSULTING SERVICES INC. THROUGH THE INCLUSION OF THE EXISTING UNDERGROUND ELECTRIC VAULT AND OIL TANK WHICH ARE SITUATED WITHIN THE BONNELL PLAZA ANEX. THE INFORMATION IS REFERENCED FROM PLAN TITLED 'GROUND FLOOR PLAN SOUTH 'C'" BY THE KLING PARTNERSHIP DATED NOVEMBER 30, 1979 AND "DETAILS & DIAGRAMS SOUTH MINT WEST" BY THE KLING PARTNERSHIP DATED NOVEMBER 30, 1979 AND LAST REVISED SEPTEMBER 1, 1912.

BENCHMARK IS CALLED OUT ON THE HUNT ENGINEERING PLANS NOTED ABOVE AT THE FOLLOWING LOCATION: 17TH STREET AND SPRING GARDEN STREET, SOUTHWEST CORNER OF INTERSECTION, EAST END OF LOWEST GRANITE STEP AT THE MAIN ENTRANCE TO LIBRARY, ELEVATION 61.21.

GRANITE SIEP AT THE MAIN ENTRANCE TO LIBRARY, ELEVATION 61.21.

3. ATTENTION IS CALLED TO THE PHILADELPHIA ZONING CODE AS AMENDED. PROPERTY IS ZONED IDD.

4. SUBJECT PREMISES DOES NOT LIE WITHIN A FLOOD HAZARD AREA. SUBJECT PREMISES IS AN AREA "X" AS PER FEDERAL EMERGENCY MANAGEMENT AGENCY FLOOD INSURANCE MAP COMMUNITY PANEL 420757—0113G, LAST REVISED JANUARY 17, 2007. UTILITIES ENTER THE PREMISES FROM PUBLIC STREETS OR RIGHT OF WAY.
NO ADDITIONAL FIELD SURVEY OR EXISTING UTILITY RESEARCH FOR PUBLIC
UTILITIES HAS BEEN PERFORMED BY STANTEC CONSULTING SERVICES INC.
SHOULD ANY DISCREPANCIES BE FOUND WITH EXISTING FEATURES DURING
CONSTRUCTION, THE CONTRACTOR SHALL REMEDY THE DISCREPANCY WITH THE OWNER OR THE OWNER'S SURVEYOR (HUNT ENGINEERING).
ALL PROPOSED UTILITY SERVICES WILL BE UNDERGROUND OR WILL ENTER PROPOSED PROPERTY FROM THE PUBLIC RIGHT-OF-WAY. THE CONTRACTOR SHALL CONFORM TO ALL THE REQUIREMENTS OF PA ACT

117 AS AMENDED. REFER TO PLAN TITLED "CIVIL EROSION AND SEDIMENT CONTROL PLAN" AND "CIVIL DETAILS — 2" DATED SEPTEMBER 23, 2009 BY HUNT ENGINEERING FOR THE APPROVED EROSION AND SEDIMENT CONTROL PLAN FOR NPDES

NOTE:
UNDERGROUND UTILITY INFORMATION DEPICTED ON PLANS IS TAKEN FROM SURVEY AND DESIGN PLANS PROVIDED BY HUNT ENGINEERING. NO ADDITIONAL FIELD SURVEY OR EXISTING JTILITY RESEARCH FOR PUBLIC UTILITIES HAS BEEN PERFORMED BY STANTEC CONSULTING SERVICES INC. SHOULD ANY DISCREPANCIES BE FOUND WITH EXISTING FEATURES DURING CONSTRUCTION, THE CONTRACTOR SHALL REMEDY THE DISCREPANCY WITH THE OWNER OR THE OWNER'S SURVEYOR

7 ISSUED FOR CONSTRUCTION	CPN	MJC	13.12.04
6 CHILLED WATER MAINS PER 6/2/1989 PLAN	CPN	MJC	13.10.25
5 CONSTRUCTION SET	CPN	MJC	13.10.18
4 ISSUED FOR OWNER REVIEW	WMC	MJC	13.08.30
3 SUBMISSION FOR STREETS DEPARTMENT REVIEW	CPN	MJC	13.08.30
2 SUBMISSION FOR OWNER'S APPROVAL	CPN	MJC	13.05.31
1 SUBMISSION TO CCP FOR BONNELL PLAZA CONSTRUCTION	CPN	MJC	13.05.10
Issued	Ву	Appd.	YY.MM.DD
File Name: 177901252-e102.dwg			
: :			
Dwn.	Chkd.	Dsgn.	YY.MM.DD

Permit-Seal


(HUNT ENGINEERING).

COMMUNITY COLLEGE OF PHILADELPHIA

PAVILION AND BONNELL PLAZAS **& 17TH STREET IMPROVEMENTS** Philadelphia, PA

17TH STREET LIGHTING PLAN

Project No. 177901252	Scale 1"=10'	
Drawing No.	Sheet	Revision
E102	13 of 14	0

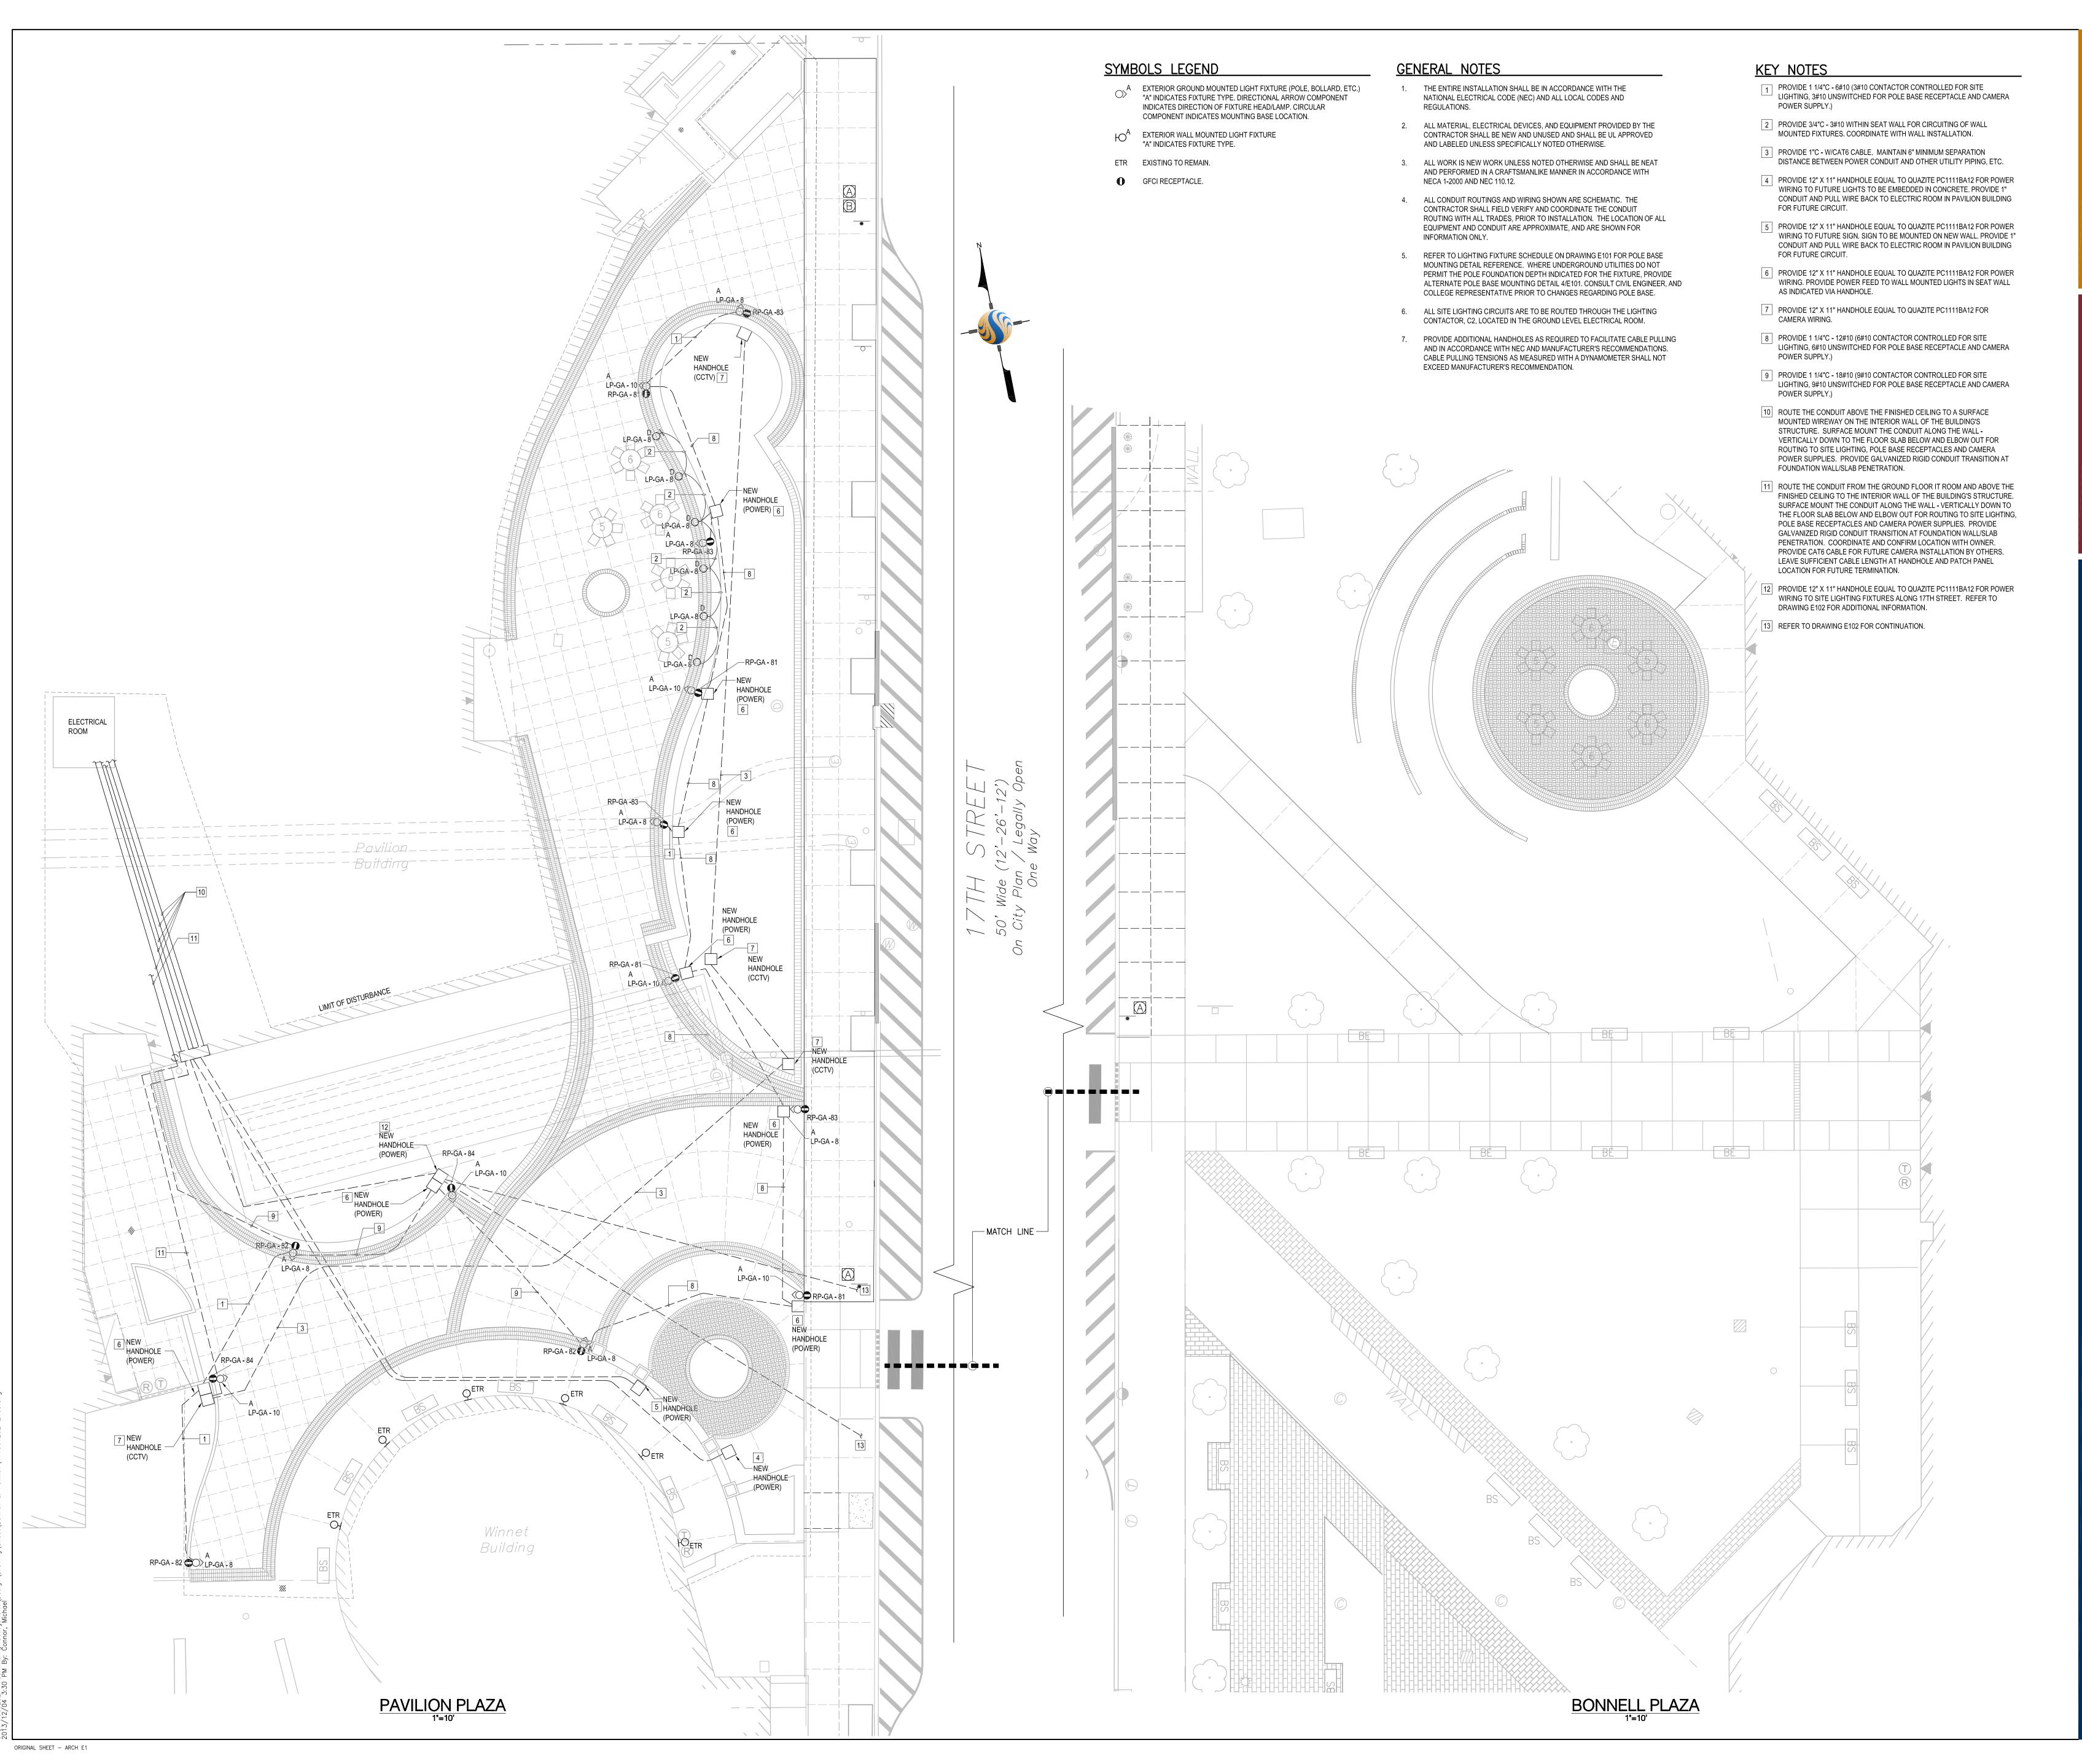


Stantec Consulting Services Inc. 1500 Spring Garden Suite 1100

Philadelphia PA 19130 Tel. 215.665.7000 Fax. 215.665.7001 www.stantec.com



Copyright Reserved

The Contractor shall verify and be responsible for all dimensions. DO NOT scale the drawing — any errors or omissions shall be reported to The Copyrights to all designs and drawings are the property of Stantec. Reproduction or use for any purpose other than that authorized by Stantec is forbidden.

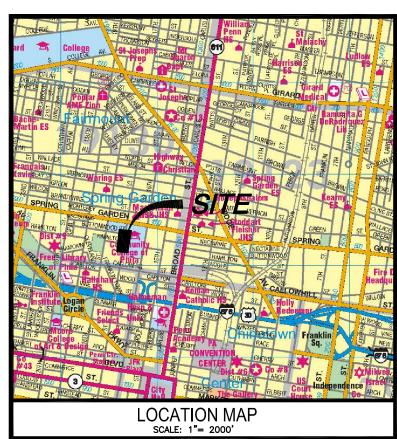

- GENERAL NOTES:

 1. ALL EXISTING CONDITION INFORMATION DEPICTED ON THE PLAN IS PER HUNT ENGINEERING PLANS TITLED "CIVIL EXISTING CONDITIONS — 1" AND "CIVIL EXISTING CONDITIONS — 2" DATED JUNE 12, 2009. THE PLAN HAS BEEN AMENDED BY STANTEC CONSULTING SERVICES INC. THROUGH THE INCLUSION OF THE EXISTING UNDERGROUND ELECTRIC VAULT AND OIL TANK WHICH ARE SITUATED WITHIN THE BONNELL PLAZA ANEX. THE INFORMATION IS REFERENCED FROM PLAN TITLED 'GROUND FLOOR PLAN SOUTH 'C'" BY
- IS REFERENCED FROM PLAN TITLED 'GROUND FLOOR PLAN SOUTH 'C'" BY
 THE KLING PARTNERSHIP DATED NOVEMBER 30, 1979 AND "DETAILS &
 DIAGRAMS SOUTH MINT WEST" BY THE KLING PARTNERSHIP DATED
 NOVEMBER 30, 1979 AND LAST REVISED SEPTEMBER 1, 1912.

 BENCHMARK IS CALLED OUT ON THE HUNT ENGINEERING PLANS NOTED
 ABOVE AT THE FOLLOWING LOCATION: 17TH STREET AND SPRING GARDEN
 STREET, SOUTHWEST CORNER OF INTERSECTION, EAST END OF LOWEST
 GRANITE STEP AT THE MAIN ENTRANCE TO LIBRARY, ELEVATION 61.21.

 ATTENTION IS CALLED TO THE PHILADELPHIA ZONING CODE AS AMENDED.
 PROPERTY IS ZONED IND. PROPERTY IS ZONED IDD.

 SUBJECT PREMISES DOES NOT LIE WITHIN A FLOOD HAZARD AREA.
- SUBJECT PREMISES IS AN AREA "X" AS PER FEDERAL EMERGENCY MANAGEMENT AGENCY FLOOD INSURANCE MAP COMMUNITY PANEL 420757—0113G, LAST REVISED JANUARY 17, 2007.

 INDICATE THE PREMISES FROM PUBLIC STREETS OR RIGHT OF WAY.

 INDICATE THE PREMISES FROM PUBLIC STREETS OR RIGHT OF WAY.

 INDICATE THE PREMISES FROM PUBLIC STREETS OR RIGHT OF WAY.

 INDICATE THE PREMISES FROM PUBLIC STREETS OR RIGHT OF WAY. UTILITIES HAS BEEN PERFORMED BY STANTEC CONSULTING SERVICES INC. SHOULD ANY DISCREPANCIES BE FOUND WITH EXISTING FEATURES DURING CONSTRUCTION, THE CONTRACTOR SHALL REMEDY THE DISCREPANCY WITH
- THE OWNER OR THE OWNER'S SURVEYOR (HUNT ENGINEERING).
 ALL PROPOSED UTILITY SERVICES WILL BE UNDERGROUND OR WILL ENTER
 PROPOSED PROPERTY FROM THE PUBLIC RIGHT—OF—WAY. THE CONTRACTOR SHALL CONFORM TO ALL THE REQUIREMENTS OF PA ACT 117 AS AMENDED.
- 9. REFER TO PLAN TITLED "CIVIL EROSION AND SEDIMENT CONTROL PLAN" AND "CIVIL DETAILS 2" DATED SEPTEMBER 23, 2009 BY HUNT ENGINEERING FOR THE APPROVED EROSION AND SEDIMENT CONTROL PLAN FOR NPDES

NOTE:
UNDERGROUND UTILITY INFORMATION DEPICTED ON PLANS IS
TAKEN FROM SURVEY AND DESIGN PLANS PROVIDED BY HUNT ENGINEERING. NO ADDITIONAL FIELD SURVEY OR EXISTING UTILITY RESEARCH FOR PUBLIC UTILITIES HAS BEEN PERFORMED BY STANTEC CONSULTING SERVICES INC. SHOULD ANY DISCREPANCIES BE FOUND WITH EXISTING FEATURES DURING CONSTRUCTION, THE CONTRACTOR SHALL REMEDY THE DISCREPANCY WITH THE OWNER OR THE OWNER'S SURVEYOR

7 ISSUED FOR CONSTRUCTION	CPN	MJC	13.12.04
6 CHILLED WATER MAINS PER 6/2/1989 PLAN	CPN	MJC	13.10.25
5 CONSTRUCTION SET	CPN	MJC	13.10.18
4 ISSUED FOR OWNER REVIEW	WMC	MJC	13.08.30
3 SUBMISSION FOR STREETS DEPARTMENT REVIEW	CPN	MJC	13.08.30
2 SUBMISSION FOR OWNER'S APPROVAL	CPN	MJC	13.05.31
1 SUBMISSION TO CCP FOR BONNELL PLAZA CONSTRUCTION	CPN	MJC	13.05.10
Issued	Ву	Appd.	YY.MM.DD

File Name: 177901252-e103.dwg Dwn. Chkd. Dsgn. YY.MM.DD Permit-Seal

Client/Project

(HUNT ENGINEERING).

COMMUNITY COLLEGE OF PHILADELPHIA

PAVILION AND BONNELL PLAZAS **& 17TH STREET IMPROVEMENTS** Philadelphia, PA

ELECTRICAL & SITE LIGHTING PLAN PAVILION PLAZA

Project No. 177901252	Scale 1"=10'	
Drawing No.	Sheet	Revision
E103	14 of 14	0